

BUILDING ALTERATION - 836 RIVER STREET

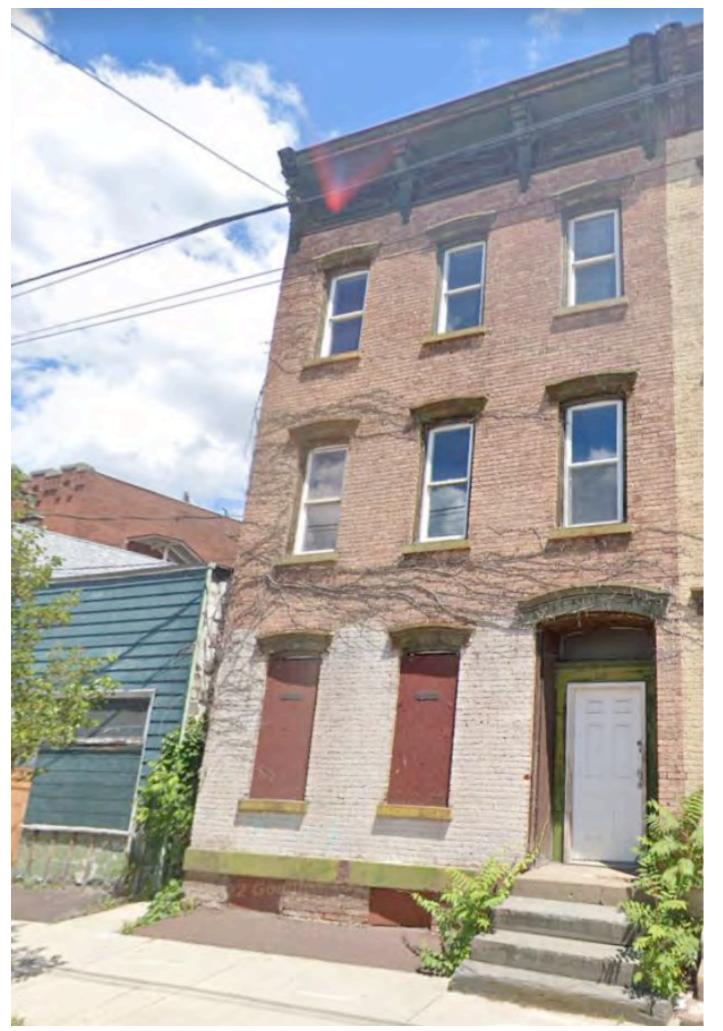

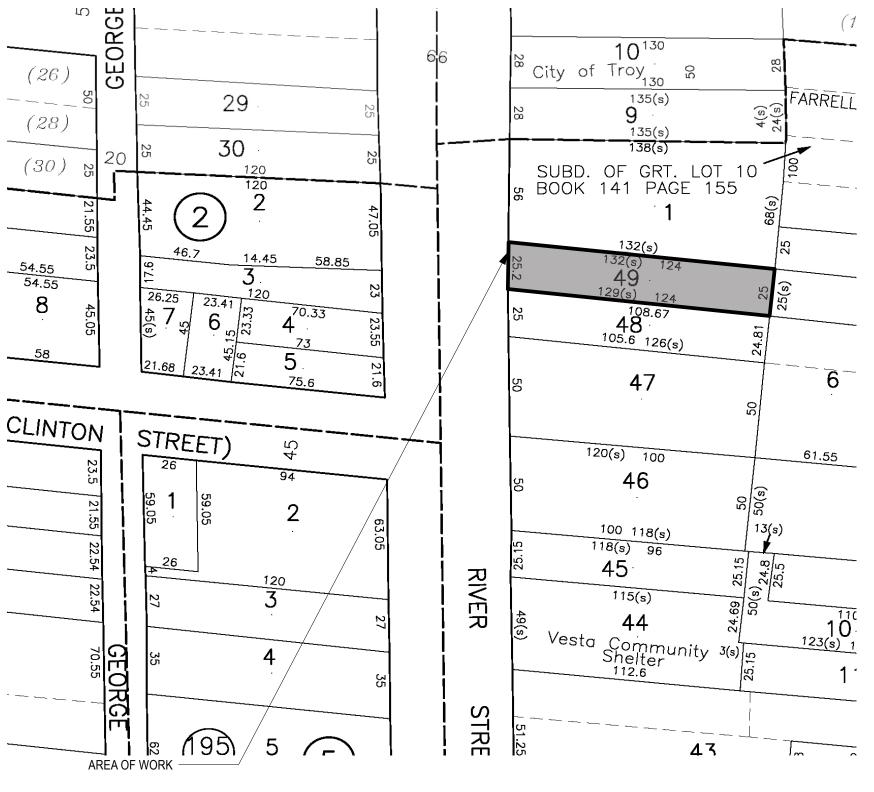

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SCOPE OF WORK:

1. RENOVATION TO EXISTING 3 FAMILY BUILDING. 2. NEW INTERIOR LAYOUT PER PLANS FOR 2 FAMILY RESIDENTIAL. 3. NO EXTERIOR WORK TO FRONT FACADE, REPAIRS ONLY. 4. MECHANICAL WORK ON SEPARATE PERMIT.

LOCATION		
LOCATION:	834 RIVER STREET TROY, NY 12180	
ZONING DISTRICT: TAX MAP:	R4 90.62-3-49	

REFERENCED CODES:

2020 RESIDENTIAL BUILDING CODES AS ADOPTED BY NEW YORK STATE, INCLUDING EXISTING BUILDING CODE (EBC), BUILDING CODE (IBC), FIRE CODE (IFC), ENERGY CONSERVATION CODE (IECC), NEW YORK STATE (NYS) 2020, 2016 & 2017 UNIFORM CODE SUPPLEMENTS, AND NYS 2016 ENERGY CODE SUPPLÈMENT.

CLASSIFICATION & USE

R-3: TWO FAMILY RESIDENTIAL

TYPE OF CONSTRUCTION: TYPE III-A, NOT SPRINKLERED

- OCCUPANCY: SINGLE-OCCUPANCY, GROUP R-3 (TWO-FAMILY RESIDENTIAL) CONSTRUCTION TYPE: TYPE III-A
- SPRINKLER SYSTEM: NON-SPRINKLERED
- FRONTAGE INCREASE: 0%
- NUMBER OF STORIES: 3 STORIES ABOVE GRADE, PLUS BASEMENT
- ALTERATION LEVEL: LEVEL 2 + CHANGE OF OCCUPANCY

ABBREVIATIONS

ABV	ABOVE	HDWR	HARDWARE
AC	AIR CONDITIONING	HDR	HEADER
ACT	ACTUAL	HW	HOT WATER
ADDN	ADDITION	ID INCLU	INTERIOR DIAMETER
ADJ	ADJUSTIBLE	INSUL	INSULATION
AFF	ABOVE FINISHED FLOOR	INT	INTERIOR
ALT	ALTERNATE	JT	JOINT KNOCK OUT
ALUM	ALUMINUM AMERICAN RIVANCOR ACCOCIATION	KO	KNOCK OUT
APA	AMERICAN PLYWOOD ASSOCIATION	LAM LAV	LAMINATE
ASF	ABOVE SUB-FLOOR		LAVATORY
AT AV C	ACOUSTIC TILE	LH LIF	LEFT HAND LOCATE IN FIELD
AVG	AVERAGE	LOC	LIMIT OF CONTRACT
AWN	AWNING	LT	LIGHT
BD BDRM	BOARD BEDROOM	LTG	LIGHTING
BFE	BOTTOM OF FOOTING ELEVATION	LVL	LAMINATED VENEER LUMBER
BLD'G	BUILDING	LIN	LINEN
BLK	BLOCK	MAT'L	MATERIAL
BLK'G	BLOCKING	MAX	MAXIMUM
BM	BEAM	MC	MEDICINE CABINET
B.M.	BENCHMARK	MDO	MEDIUM DENSITY OVERLAY PLYWOOD
BO.WI.	BOTTOM OF	MFG	MANUFACTURER
B/S	BOTH SIDES	MIN	MINIMUM
BTWN	BETWEEN	MO	MASONRY OPENING
BTU	BRITISH THERMAL UNITS PER HOUR	MTD	MOUNTED
CAB	CABINET	MTL	METAL
CDX	CD PLYWOOD, EXT GLUE	NIC	NOT IN CONTRACT
CHIM	CHIMNEY	NO	NUMBER
CL	CLOSET	NTS	NOT TO SCALE
CLG	CEILING	OC	ON CENTER
CMU	CONCRETE MASONRY UNIT	OPG	OPENING
COL	COLUMN	PL	PLATE
CONC	CONCRETE	PLAS	PLASTIC
CONST	CONSTRUCTION	PLWD	PLYWOOD
CONT	CONTINUOUS	PT	PRESSURE TREATED
CSMT	CASEMENT	PTD	PAINTED
CT	CERAMIC TILE	PTS	PLUGGED/TOUCH-SANDED PLYWOOD
D	CLOTHES DRYER	QTY	QUANTITY
DIA	DIAMETER	R	RISER
DBL	DOUBLE	RD	ROUND
DH	DOUBLE HUNG	REF	REFRIGERATOR
DIM	DIMENSION	REQ'D	REQUIRED
DN	DOWN	RT	RIGHT HAND
DR	DOOR	RO	ROUGH OPENING
DW	DISHWASHER	RT	RAFTER
DWG	DRAWING	SDL	SIMULATED DIVIDED LIGHT
E	EAST	SHWR	SHOWER
EL	ELEVATION	SHT	SHEET
ELEC	ELECTRIC	SIM	SIMILAR
ENCL	ENCLOSURE	STD	STANDARD
EPDM	ETHYLENE PROPYLENE DIENE MONOMER	STL	STEEL
EXT	EXTERIOR	SUBFL	SUBFLOOR
EXTG	EXISTING	SYM	SYMBOL
FD	FLOOR DRAIN	<u>T</u>	TREAD
FF	FINISH FLOOR	TEL	TELEPHONE
FO	FACE OF	TBA	TO BE ANNOUNCED
FDN	FOUNDATION	TBD	TO BE DETERMINED
FIN	FINISH (ED)	TO FINE	TOP OF
FL	FLOOR (ING)	T.O.FINFL	TOP OF FINISH FLOOR
FT	FOOT/FEET	TOL	TOP OF LEDGE
FTG	FOOTING	TOS	TOP OF SLAB
FOF	FACE OF FRAMING	T.O.SUBFL	TOP OF SUBFLOOR
F.O.FIN	FACE OF FINISH	TOW	TOP OF WALL
FP	FIREPLACE	TYP	TYPICAL
FRMGX	FRAMING	TV	TELEVISION
GC	GENERAL CONTRACTOR	UNO	UNLESS NOTED OTHERWISE
GL	GLASS CYDSUM WALL BOARD	VB VIF	VAPOR BARRIER
GWB	GYPSUM WALLBOARD	W.	VERIFY IN FIELD WITH
		VV.	VVIIII

GENERAL NOTES

- 1. Before commencing all work, the contractor shall file all required insurance certificates, obtain all required permits, and pay all fees required by the
- 2. All work shall conform to the requirements of the Building Code, Fire Department Rules and Regulations, utility company requirements, and the best trade practices. All wood to be used shall be fire-rated. 3. Minor details not usually shown or specified, but required for proper construction of any part of the work shall be included as if they were indicated in the
- 4. The contractor shall coordinate all work procedures with the stipulation of the local authorities.
- 5. The contractor shall be responsible for the protection of all conditions and materials within the proposed construction area. The contractor shall design and install adequate shoring and bracing for all structural and removing tasks. The contractor shall have sole responsibility for any damage or injuries
- caused by or during the execution of work. 6. The contractor shall lay out his own work, and shall provide all dimensions required for the other trades: plumbing, electrical, etc. 7. Plumbing work shall be performed by the persons licensed in their trades, who shall arrange for and obtain all required permits, inspections, and required
- 8. All new Electrical work, modifications, repairs, etc. shall be performed by persons licensed in their trades, who shall arrange for and obtain all required permits, inspections and required sign offs.
- 9. The contractor shall do all cutting, patching, repairing as required to perform all the work indicated on the drawings, and all other work that may be
- required to complete the job. 10. The contractor is to post all required permits on site prior to any work performed.
- 11. The contractor shall have all materials proposed for demolition be tested for possible asbestos and/or lead content before they are disturbed. Asbestos and lead containing materials can only be disturbed, removed or abated by properly trained and certified personnel as per applicable codes, rules and



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PROJECT

BUILDING ALTERATION 836 RIVER STREET

TROY, NY 12180

ISSUED FOR

PERMIT

04/30/25

DRAWING TITLE

REVISION:

COVER

DRAWING NUMBER

CODE NOTES

NEW YORK STATE RESIDENTIAL CODE 2020 APPENDIX J FOR EXISTING BUILDINGS

NEW YORK SECTION AJ601 ALTERATIONS - LEVEL 2

AJ601.6.1 Separation Required

Where the work area is in a two-family dwelling or multiple single-family dwelling (townhouse) and exceeds 50 percent of the aggregate area of the dwelling unit, all walls separating dwelling units that are not continuous from the foundation to the underside of the roof sheathing shall be constructed to provide a continuous fire separation using construction materials consistent with the existing wall or complying with the requirements for new structures. Work shall only be required to be performed on the side of the wall of the dwelling unit that is part of the work

ONE HOUR CONTINUOUS FIRE SEPARATION BETWEEN THE TWO UNITS IS REQUIRED AND PROPOSED.

AJ601.6.2 Wall and Ceiling Finish

Where the work area exceeds 50 percent of the aggregate area of the dwelling, the interior finish of walls and ceilings in any work area shall comply with the requirements of Section R302.9. All existing interior finish materials that do not comply with those requirements shall be removed or shall be treated with an approved fire retardant coating in accordance with the manufacturer's instructions to secure compliance with the requirements of this section.

INTERIOR FINISH OF WALLS AND CEILINGS TO COMPLY WITH SECTION R302.9 AS REQUIRED.

In work areas, guards designed and installed in accordance with Section R312 shall be provided on every open portion of a floor, stair, landing, porch, deck, porch or deck enclosed with insect screening, or balcony that is more than 30 inches (762 mm) above the floor or grade below, or where the existing guards are judged to be in danger of collapsing.

GUARDS TO BE INSTALLED WHERE NECESSARY TO COMPLY WITH SECTION R312.

AJ601.7 Means of Egress The means of egress in work areas where alterations are being performed shall comply with the requirements of this section.

AJ601.7.1 Exit Doors

Exit doors in any work area shall comply with Section R311.1 and R311.2.

AJ601.7.2 Handrails Every stairway having four or more risers from a work area floor shall be provided with handrails designed and installed in accordance with

ALL EXIST DOORS TO COMPLY WITH SECTIONS R311.1 AND R311.2. GUARDS TO BE INSTALLED WHERE NECESSARY TO COMPLY WITH SECTION R312.

AJ601.8 Fire and Life Safety Protection

Refer to AJ701.3 for Change of Use requirements

AJ601.9.1 Increased Loads

The minimum design criteria for existing portions of the structure shall be the loads applicable at the time the building was constructed, provided that no dangerous condition is created. Structural elements which are uncovered during the course of the alteration and which are found to be unsound or dangerous shall be made to comply with the applicable requirements of this code.

Where alteration work includes installation of additional equipment that is structurally supported by the building or reconfiguration of space such that portions of the building become subjected to higher dead or live loads, all structural members affected by such increase shall meet the load requirements of this code.

Exception: Structural elements whose stress is not increased by more than 5 percent. AJ601.9.2 Reduction of Strength

Alterations shall not reduce the structural strength or stability of the building, structure or any individual member thereof.

Exception: Such reduction shall be allowed as long as the strength and the stability of the building are not reduced to below the levels required by this code.

AJ601.9.3 New Structural Members

New structural members in alterations, including connections and anchorage, shall comply with this code.

NO INCREASED LOADS PROPOSED. GC TO INSPECT EXISTING STRUCTURE CAREFULLY AND ENGAGE STRUCTURAL ENGINEER FOR ANY REPAIRS OR ALTERATION.

Alterations to any mechanical system shall conform to the requirements of Chapter 12 for a new mechanical systemwithout requiring the existing mechanical system to comply with all the requirements of this code. Alterations shall not cause an existing mechanical system to become unsafe, hazardous or overloaded.

AJ601.10.1 Reconfigured Spaces

Mechanically ventilated reconfigured spaces shall comply with Section M1505 as applicable

ALL NEW MECHANICAL WORK TO COMPLY WITH REQUIREMENTS OF CHAPTER 12. ALL WORK UNDER SEPARATE PERMIT.

AJ601.11 Plumbing

Alterations to any plumbing system shall conform to the requirements for a new plumbing system without requiring the existing plumbing system to comply with all the requirements of this code. Alterations shall not cause an existing system to become unsafe, unsanitary or overloaded. AJ601.11.1 Increased Demand

Where any alteration subjects any portion of an existing plumbing system to increased loads, such portion shall be made to comply with Chapters 25 through 33.

ALL NEW PLUMBING WORK TO BE PERFORMED BY A LICENSED PLUMBER PER DRAWINGS AND TO COMPLY WITH CURRENT PLUMBING AND BUILDING CODES AND REQUIREMENTS.

AJ601.12 Electrical

Any alteration to an existing electrical system relating to work done in any work area shall be made in conformity with the provisions of Chapters AJ601.12.1 Increased Loads

Where alterations subject portions of existing electrical systems to increased loads, such portions shall be made to comply with Chapter 34

through Chapter 43. AJ601.12.2 Electrical Service

Service to dwelling units shall be a minimum of 100 ampere, three-wire capacity, and service equipment shall be dead front having no live parts exposed whereby accidental contact could be made. Type "S" fuses shall be installed when fused equipment is used. Exception: Existing service of 60 ampere, three-wire capacity, and feeders of 30 ampere or larger two-or three-wire capacity shall be accepted if

adequate for the electrical load being served. AJ601.12.2.1 Clearance

Clearance for electrical service equipment shall be provided in accordance with Section E3405.

AJ601.12.3 Ground-Fault and Arc-Fault Circuit Interrupter Protection

Ground-fault and arc-fault circuit-interrupter protection shall be provided on newly installed receptacle outlets as required by Section E3902. AJ601.12.4 Additional Electrical Requirements When the work area includes any of the following areas within a dwelling unit, the requirements of Sections AJ608.5.1 through AJ608.5.3 shall

AJ601.12.4.1 Enclosed Areas

All enclosed areas other than closets, kitchens, basements, garages, hallways, laundry areas and bathrooms shall have a minimum of two duplex receptacle outlets, or one duplex receptacle outlet and one ceiling or wall type lighting outlet. AJ601.12.4.2 Kitchen and Laundry Areas

Kitchen areas shall have a minimum of two duplex receptacle outlets. Laundry areas shall have a minimum of one duplex receptacle outlet located near the laundry equipment and installed on an independent circuit.

AJ601.12.4.3 Bathrooms, Hallways, Stairways, Attached and Detached Garages

At least one lighting outlet shall be provided in every bathroom, hallway, stairway, attached garage and detached garage with electric power to illuminate outdoor entrances and exits, and in utility rooms and basements where these spaces are used for storage or contain equipment requiring service.

ALL NEW ELECTRICAL WORK TO BE PERFORMED BY LICENSED ELECTRICIAN AND TO COMPLY WITH CURRENT ELECTRICAL AND BUILDING CODES AND REQUIREMENTS PER DRAWINGS AND SPECIFICATIONS.

NEW YORK SECTION AJ701 CHANGE OF OCCUPANCY

AJ701.2.1 Existing Emergency Escape and Rescue Openings

Emergency escape and rescue openings need not meet the requirements of this code where such openings were lawfully in existence at the

ALL EXISTING WINDOW OPENINGS TO REMAIN NEED NOT MEET EMERGENCY RESCUE REQUIREMENTS.

AJ701.2.2 Existing Stairs

Existing stairs are permitted to remain, provided all of the following conditions are met:

- 1. The product obtained by multiplying the height of the riser by the depth of the tread shall be not less than 70 inches (1778 mm) nor more than 80 inches (2032 mm). Riser height shall not exceed 9 inches (229 mm).
- 2. Stairs shall have minimum headroom of 6 feet 6 inches (1981 mm), except that stairs for occasional use to basements and attics are permitted to have minimum headroom of 6 feet 4 inches (1930 mm).
- 3. Variations in riser height in a run of stairs shall not exceed 3/8 inch (9.5 mm).
- 4. Width shall be not less than 30 inches (762 mm).

GC TO VERIFY EXISTING STAIRS MEETS ALL REQUIREMENTS ABOVE OR MODIFY ACCORDINGLY.

Existing ceiling heights shall be permitted to remain if they equal or exceed the following: 1 Habitable space shall have a ceiling height of not less than 6 feet 8 inches (2032 mm), measured from the finished floor to the lowest

2 Space, other than habitable, shall have a ceiling height of not less than 6 feet 6 inches (1981 mm), measured from the finished floor t

ALL EXISTING AND PROPOSED CEILING HEIGHTS ABOVE REQUIRED 6'-8".

AJ701.2.4 Existing Foundations

Existing foundations are permitted to remain where the change in use will increase the soil bearing pressure by no more than 5 percent.

NO FOUNDATION WORK REQUIRED NOR PROPOSED.

o the lowest projection from the ceiling.

AJ701.2.5 Seismic Load Provisions

Specific seismic load detailing provisions required for new structures are not required to be met where it can be shown that an acceptable level of performance and seismic safety is obtained for the applicable seismic design category.

SEISMIC LOAD NOT REQUIRED.

AJ701.3 Fire and Life Safety Protection

AJ701.3.1 Smoke Alarms

Smoke alarms, located as required for new dwellings, shall be provided; the smoke alarms shall be interconnected in accordance with Section

HARDWIRED AND INTERCONNECTED SMOKE ALARMS PER SECTION R314.4 REQUIRED AND PROPOSED.

AJ701.3.2 Carbon Monoxide Alarms

Where a building undergoes a change of occupancy to a dwelling unit, carbon monoxide alarms shall be provided throughout the dwelling unit. The selection, design, and location of carbon monoxide alarms shall comply with the requirements for new construction. AJ701.3.2.1 Power Supply and Interconnection

Carbon monoxide alarms powered by a 10-year battery shall be allowed and interconnection of alarms shall not be required in: 1 Buildings that undergo a change of occupancy unless otherwise required by other applicable provisions of the Uniform Code.

2 Dwelling units without commercial power.

HARDWIRED AND INTERCONNECTED CARBON MONOXIDE ALARMS PROPOSED.

AJ701.3.3 Automatic Fire Sprinkler System

An automatic sprinkler system as required for new dwellings shall be provided.

AUTOMATIC SPRINKLER SYSTEM NOT REQUIRED AS NO NEW DWELLINGS ARE PROPOSED.



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BUILDING ALTERATION 836 RIVER STREET

TROY. NY 12180

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04/30/25

DRAWING TITLE

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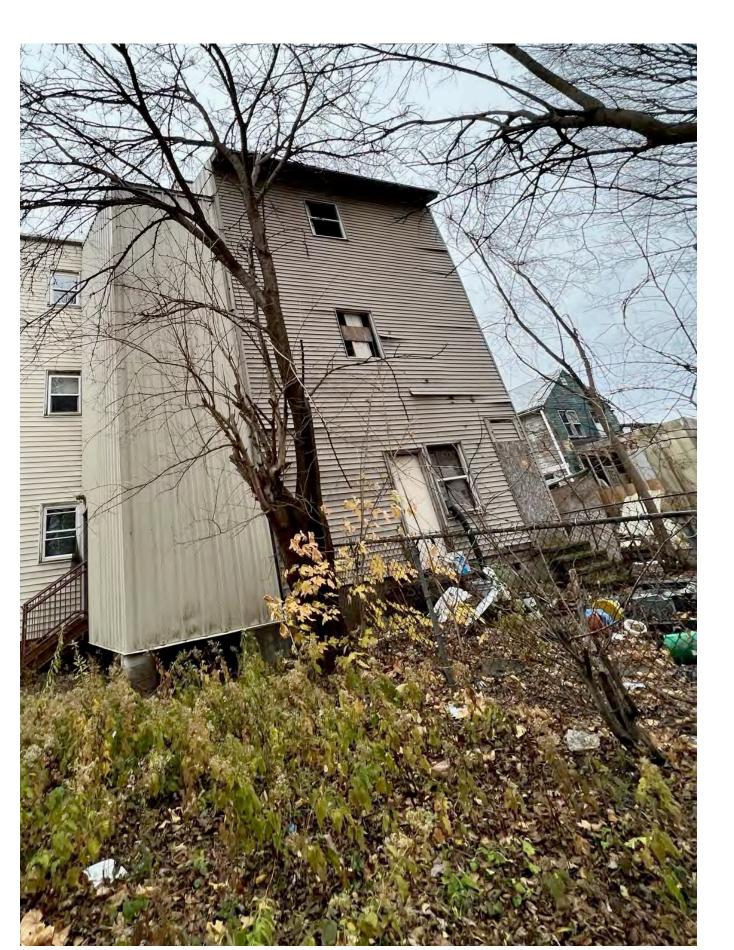
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2 REAR ELEVATION - EXISTING PHOTOS



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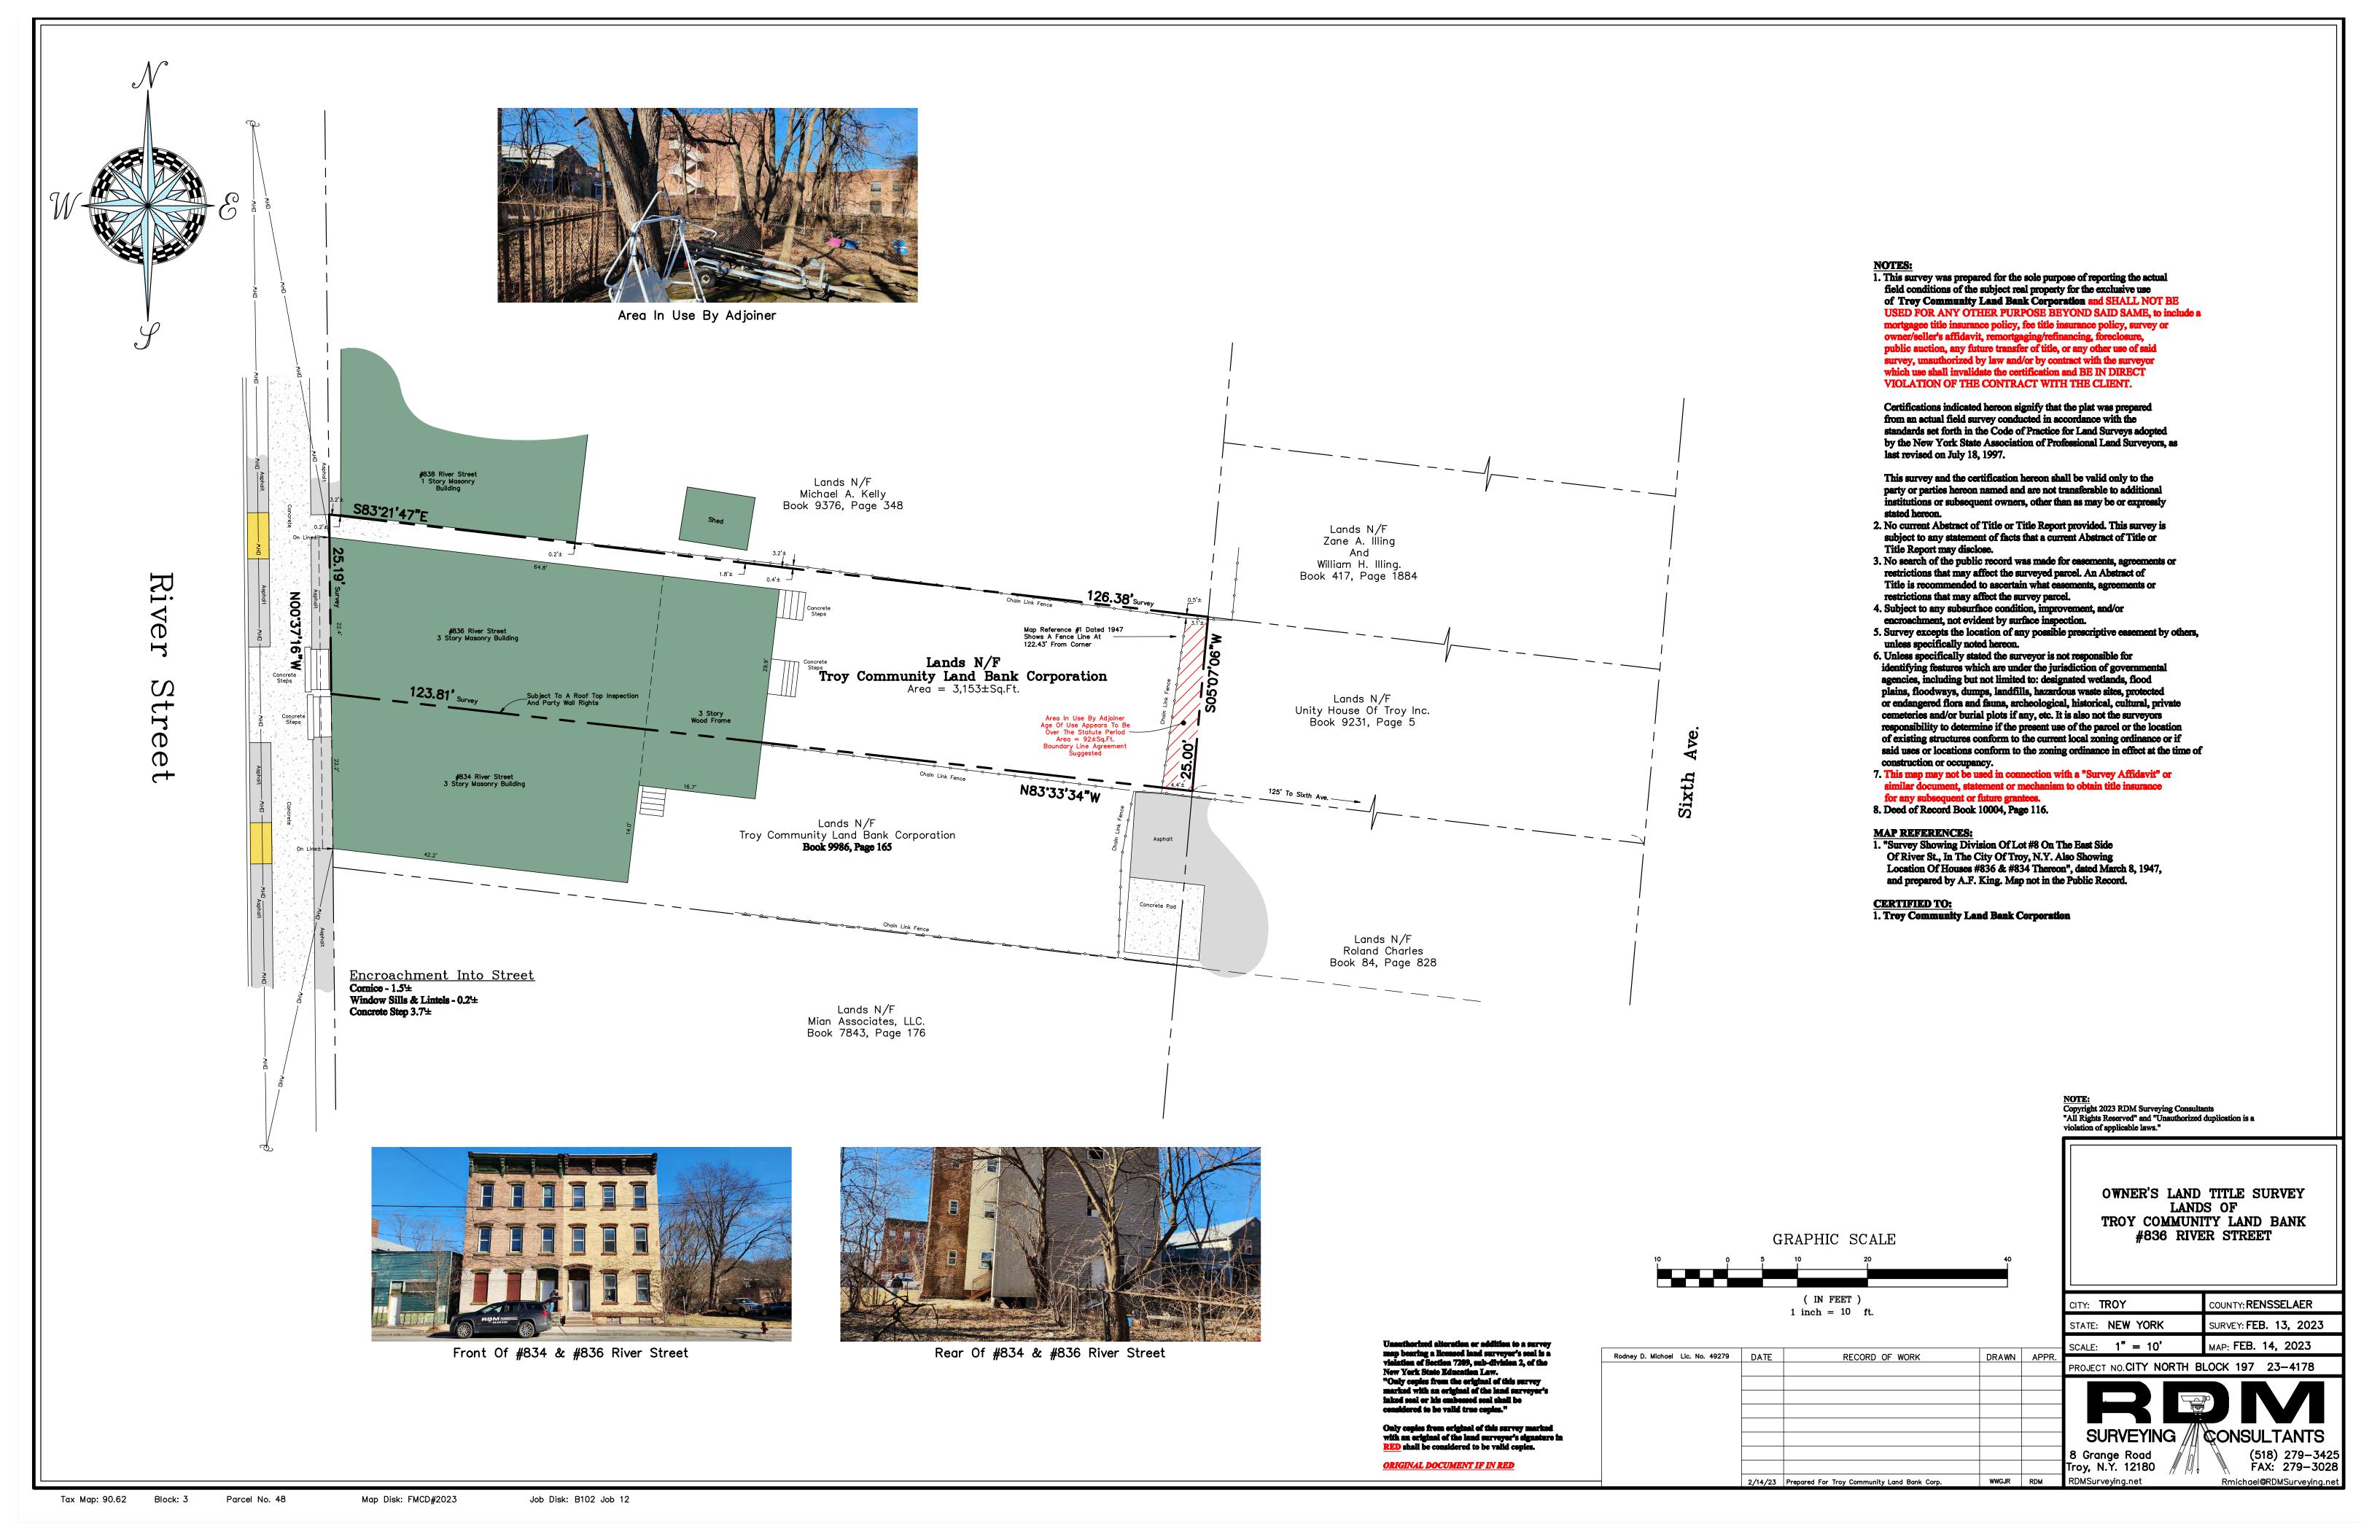
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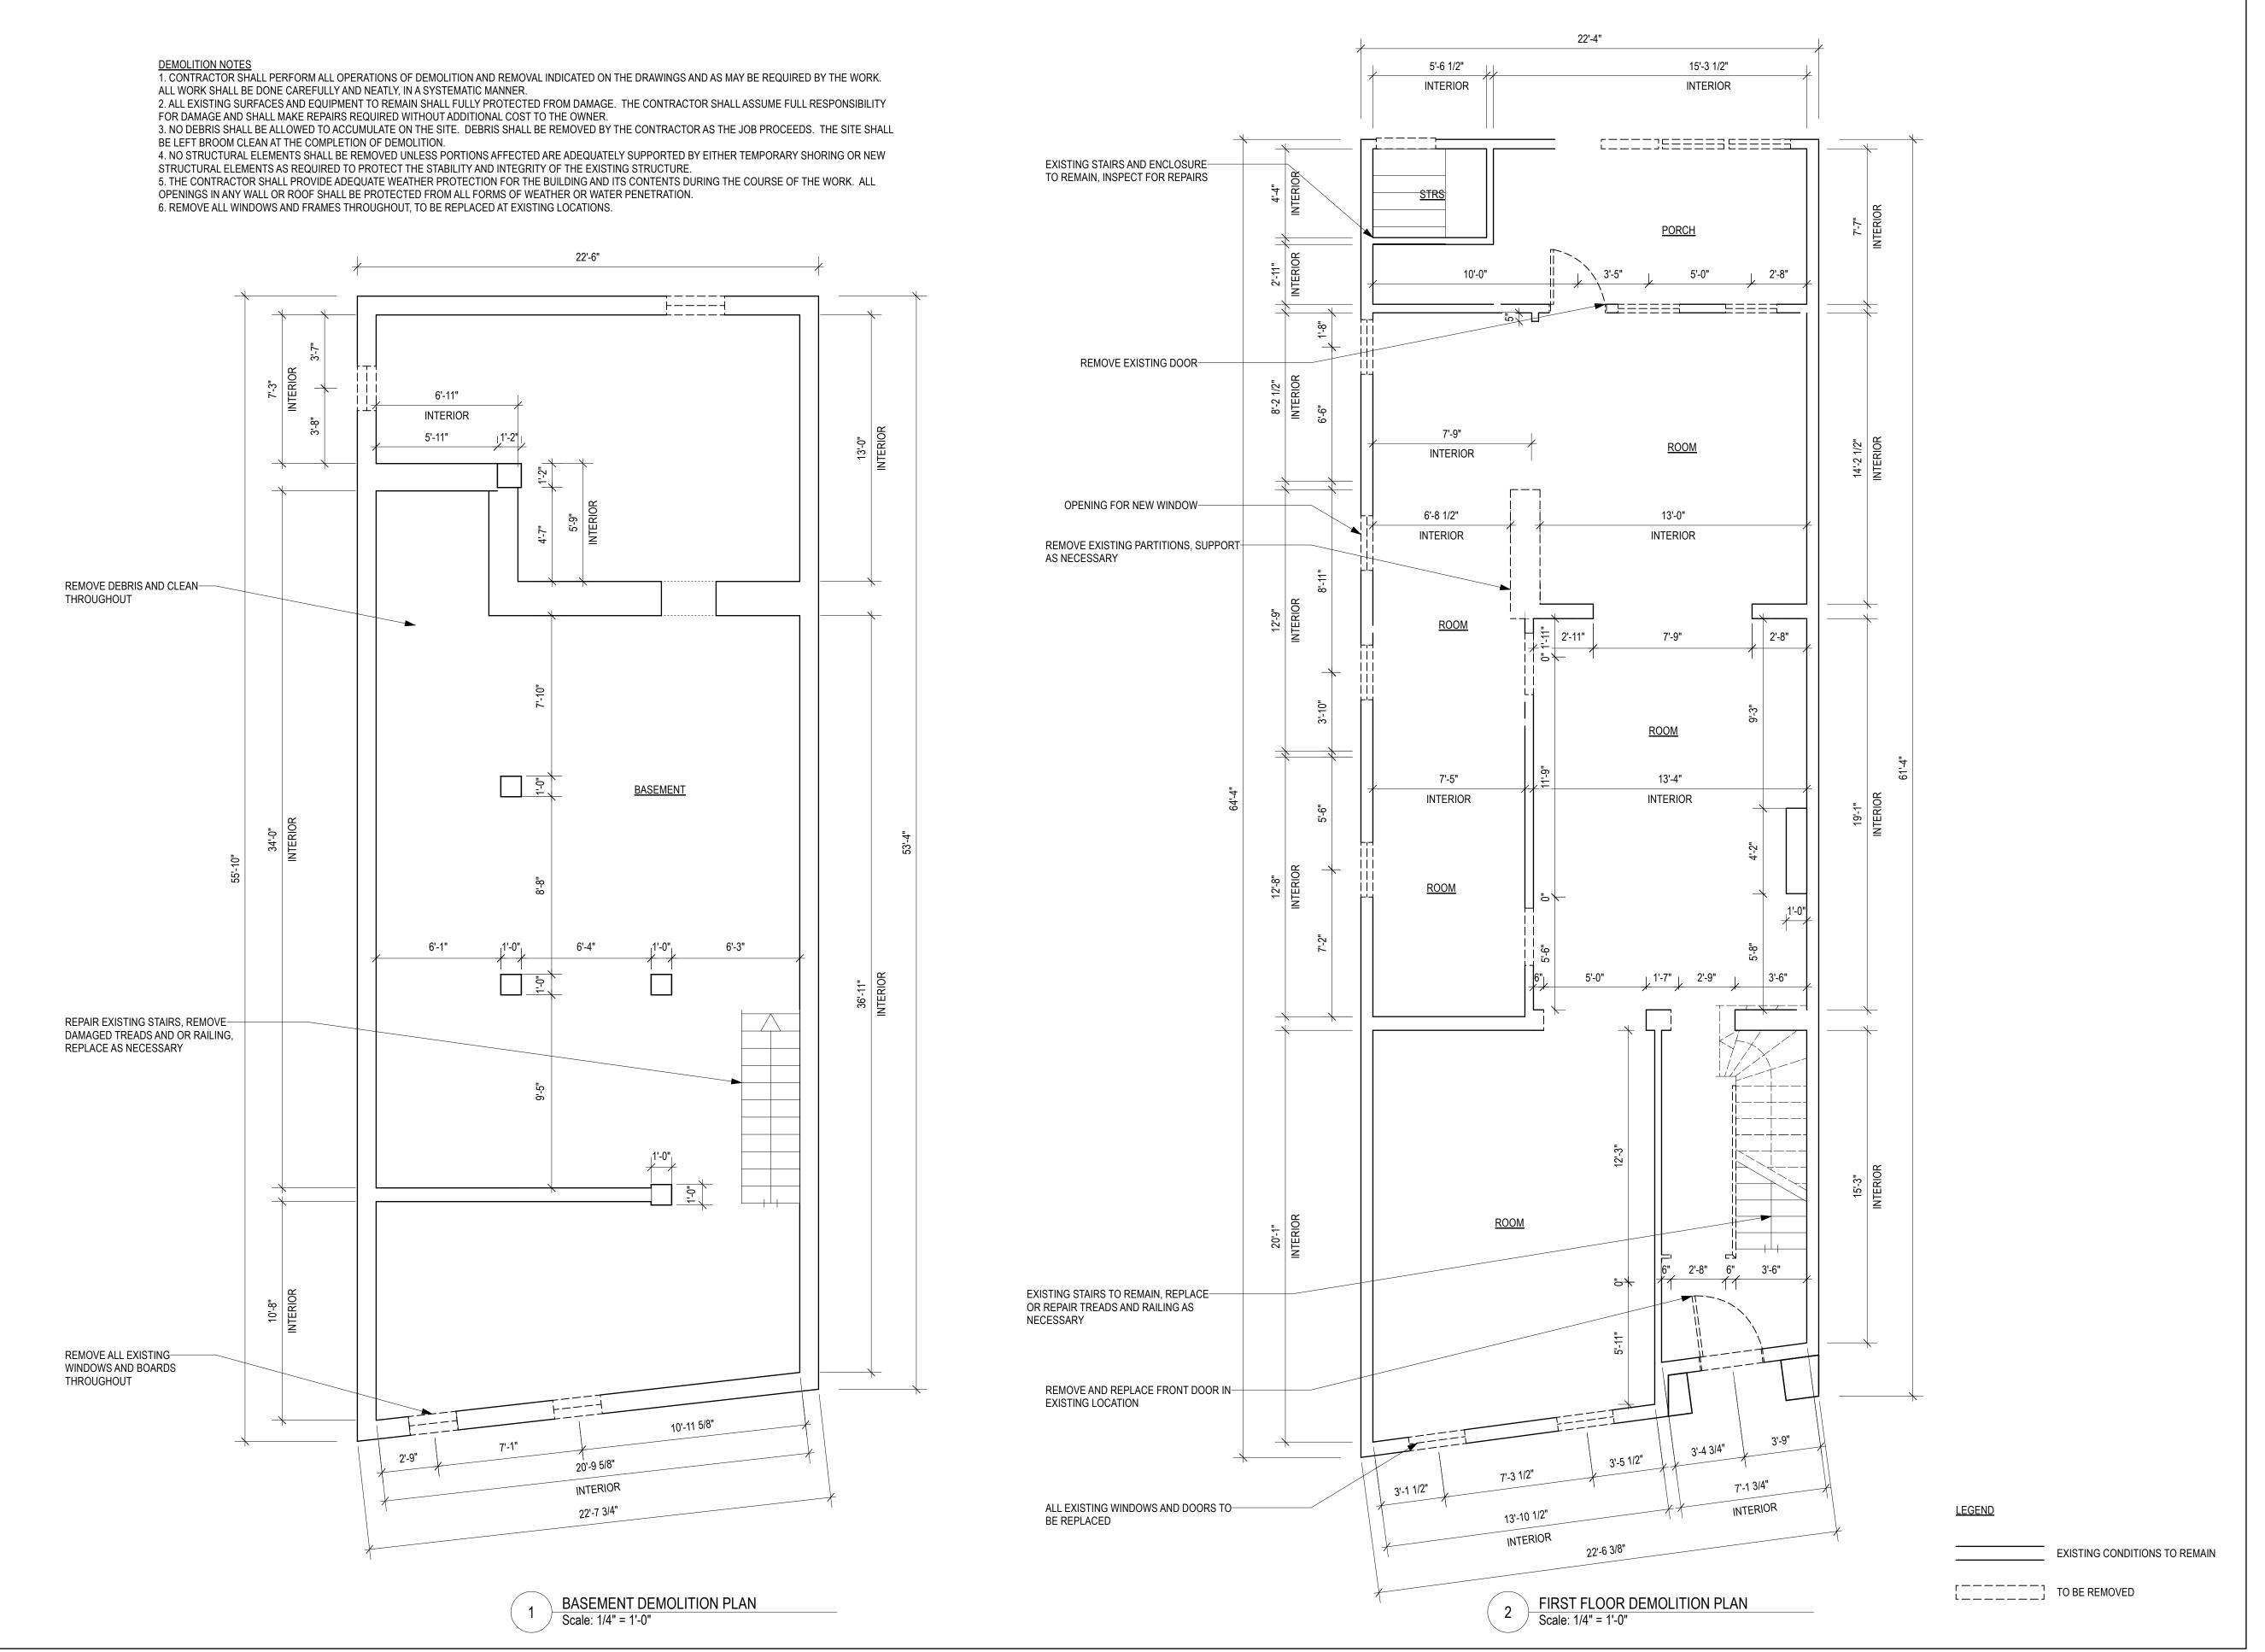
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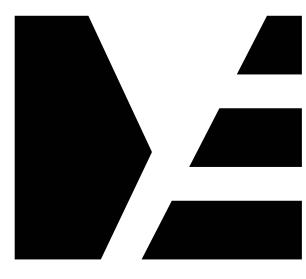
EXISTING PHOTOS

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G-03







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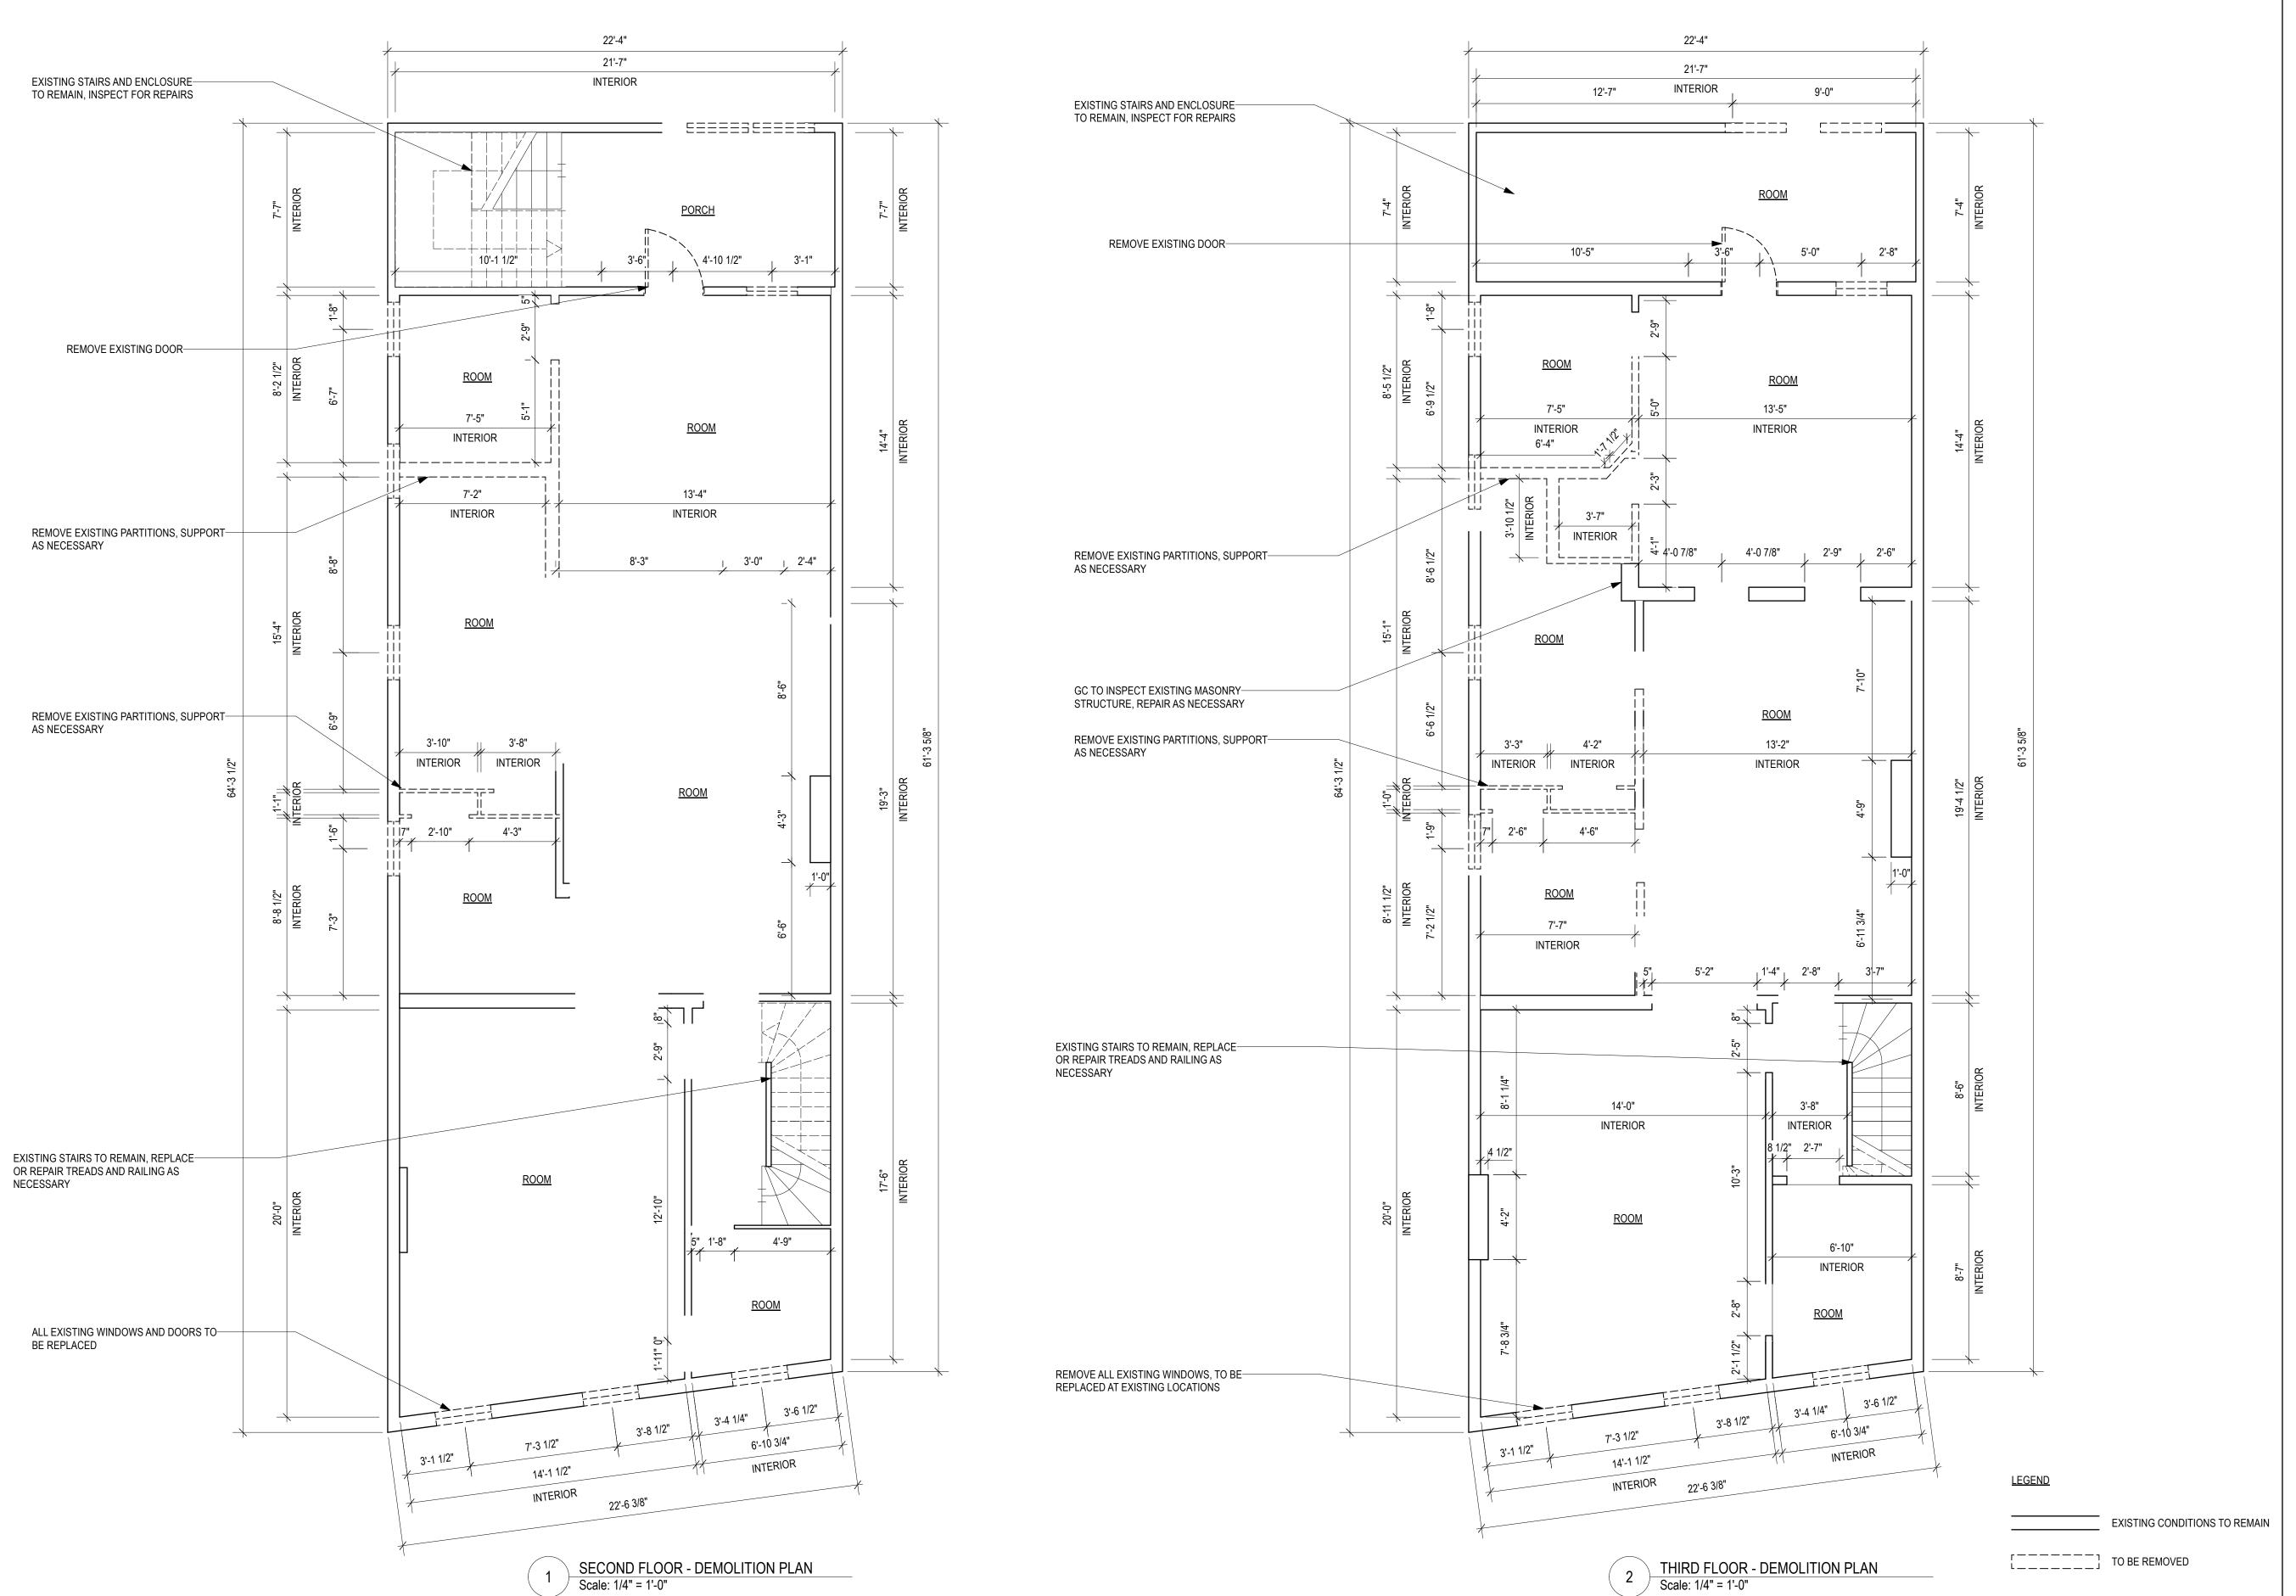
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DAWING TITLE

BASEMENT & FIRST FLOOR DEMOLITION PLAN

DRAWING NUMBER

D-100





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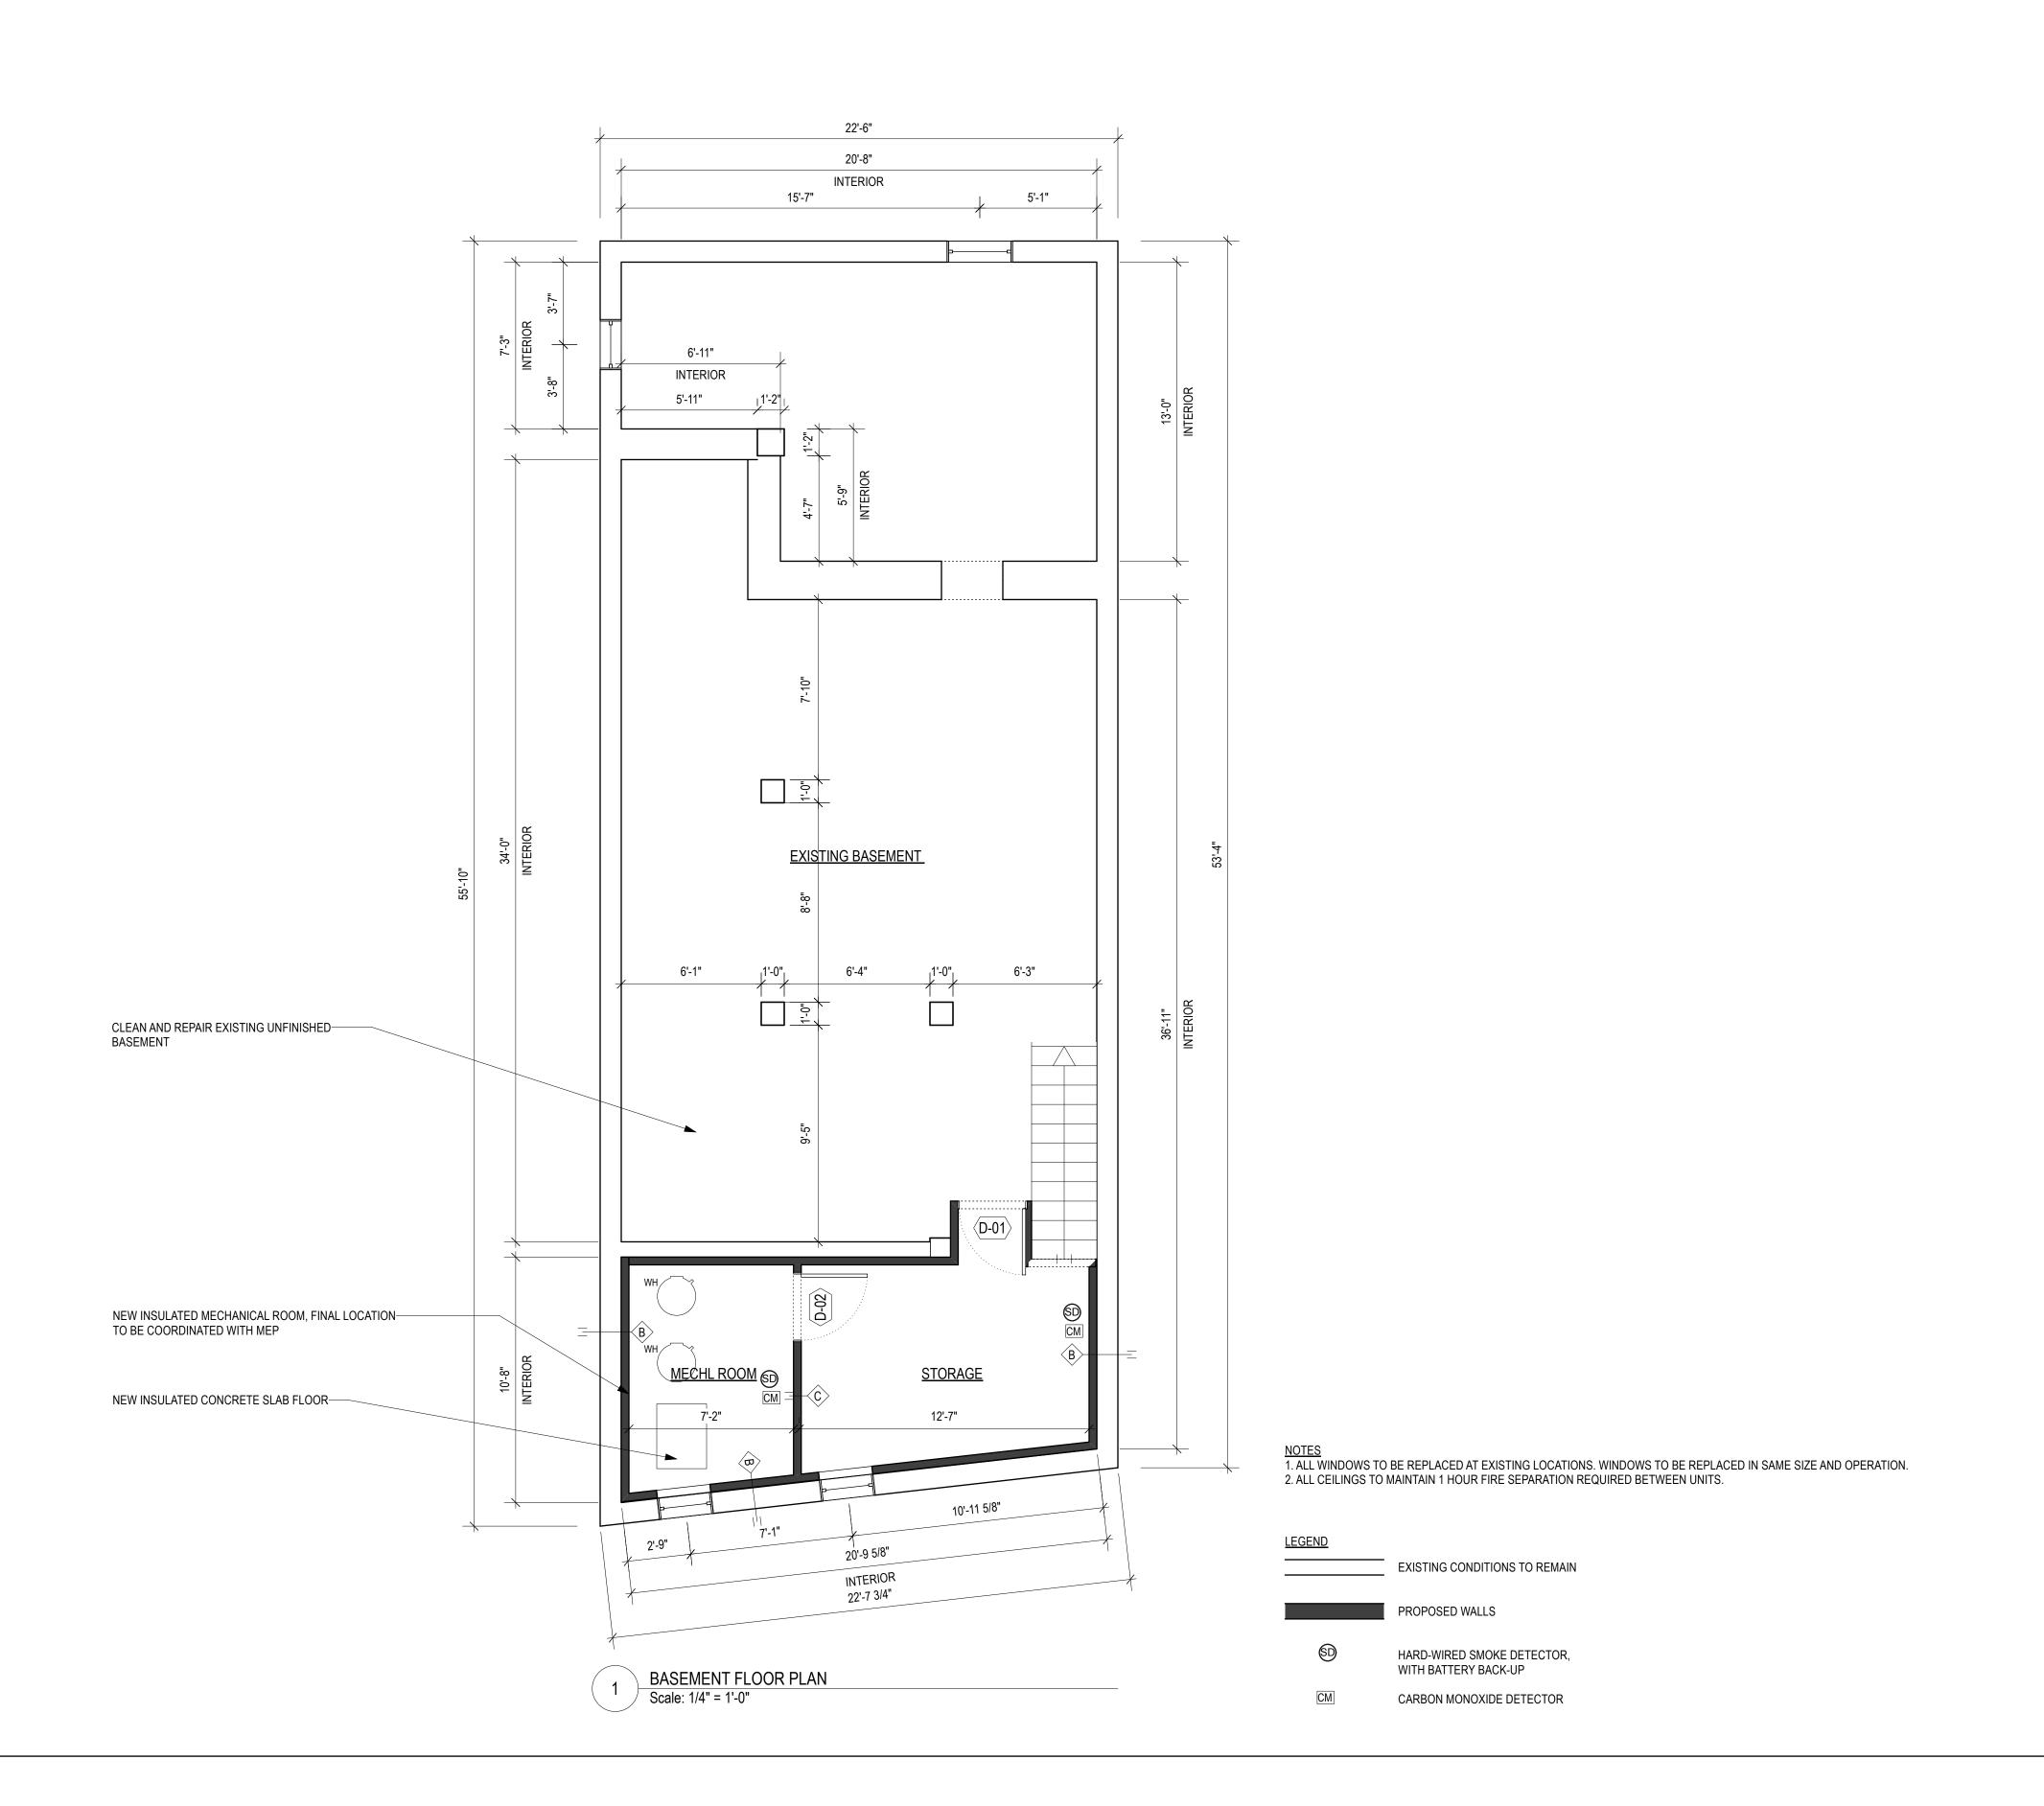
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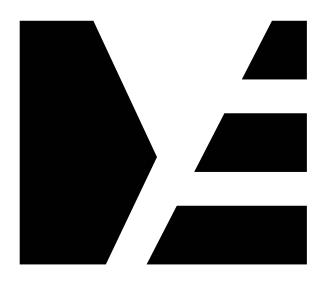
DRAWING TITLE

SECOND & THIRD DEMOLITION PLAN

DRAWING NUMBER

D-101





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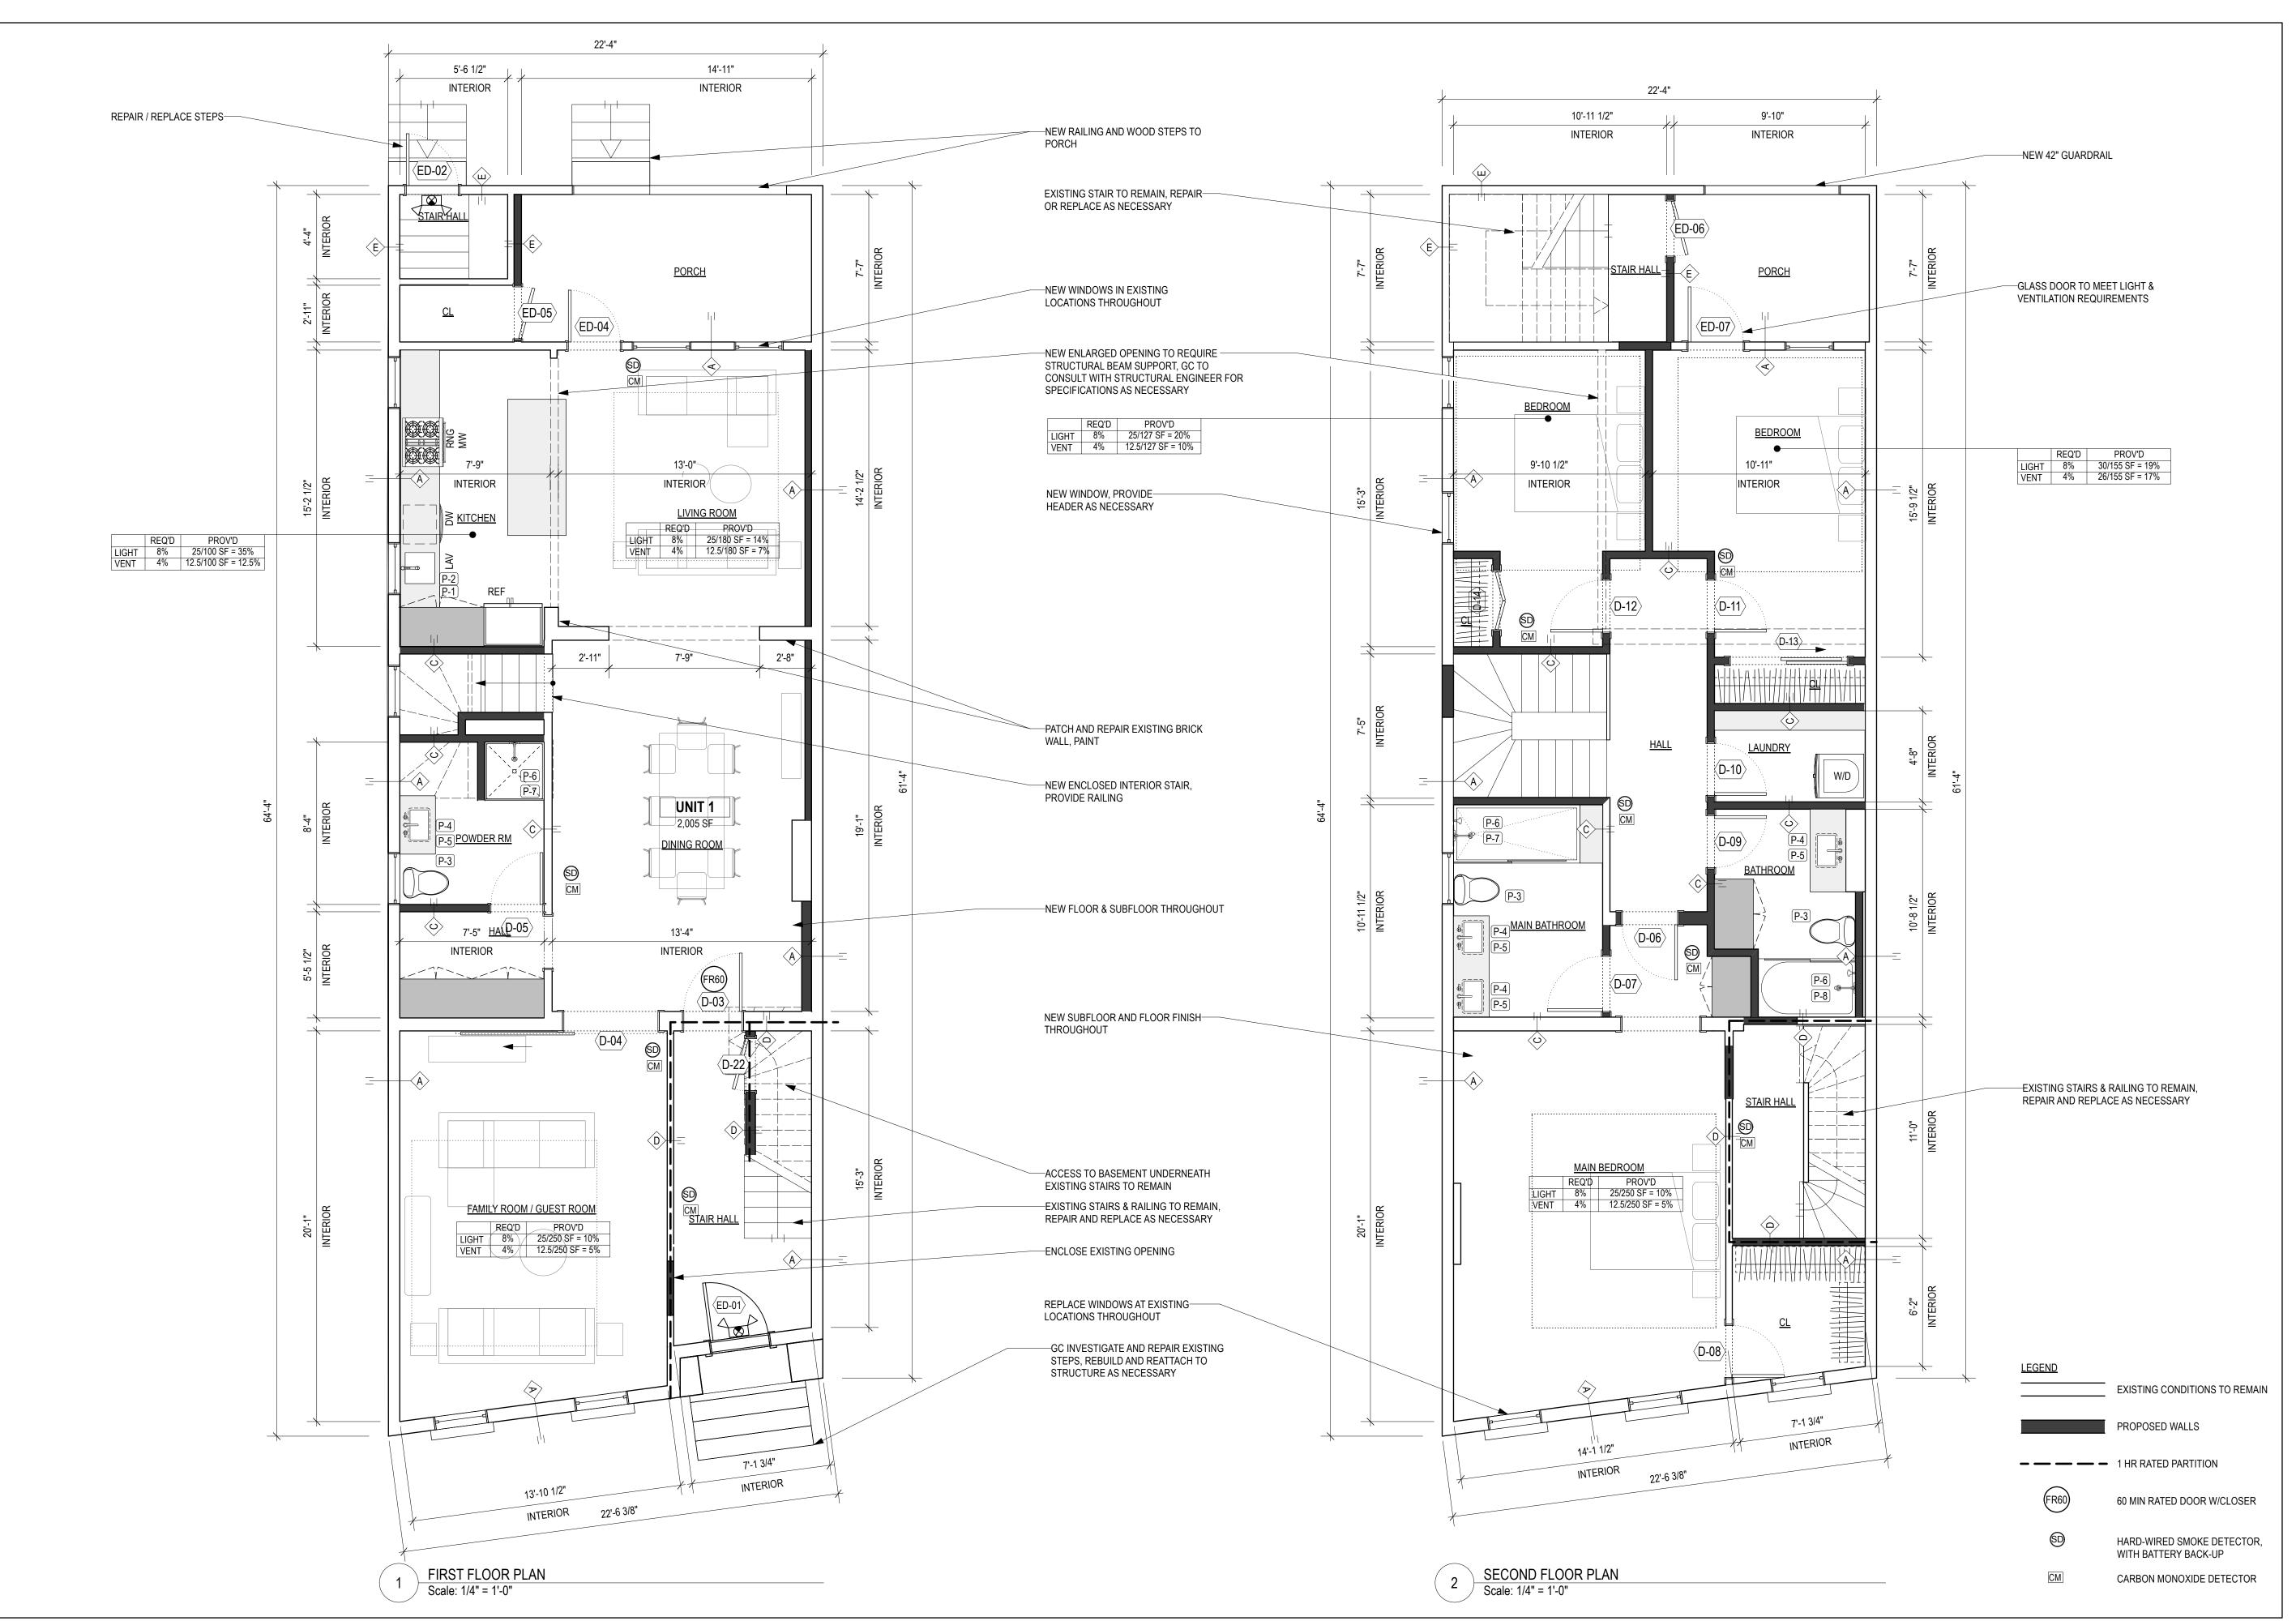
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BASEMENT FLOOR PLAN

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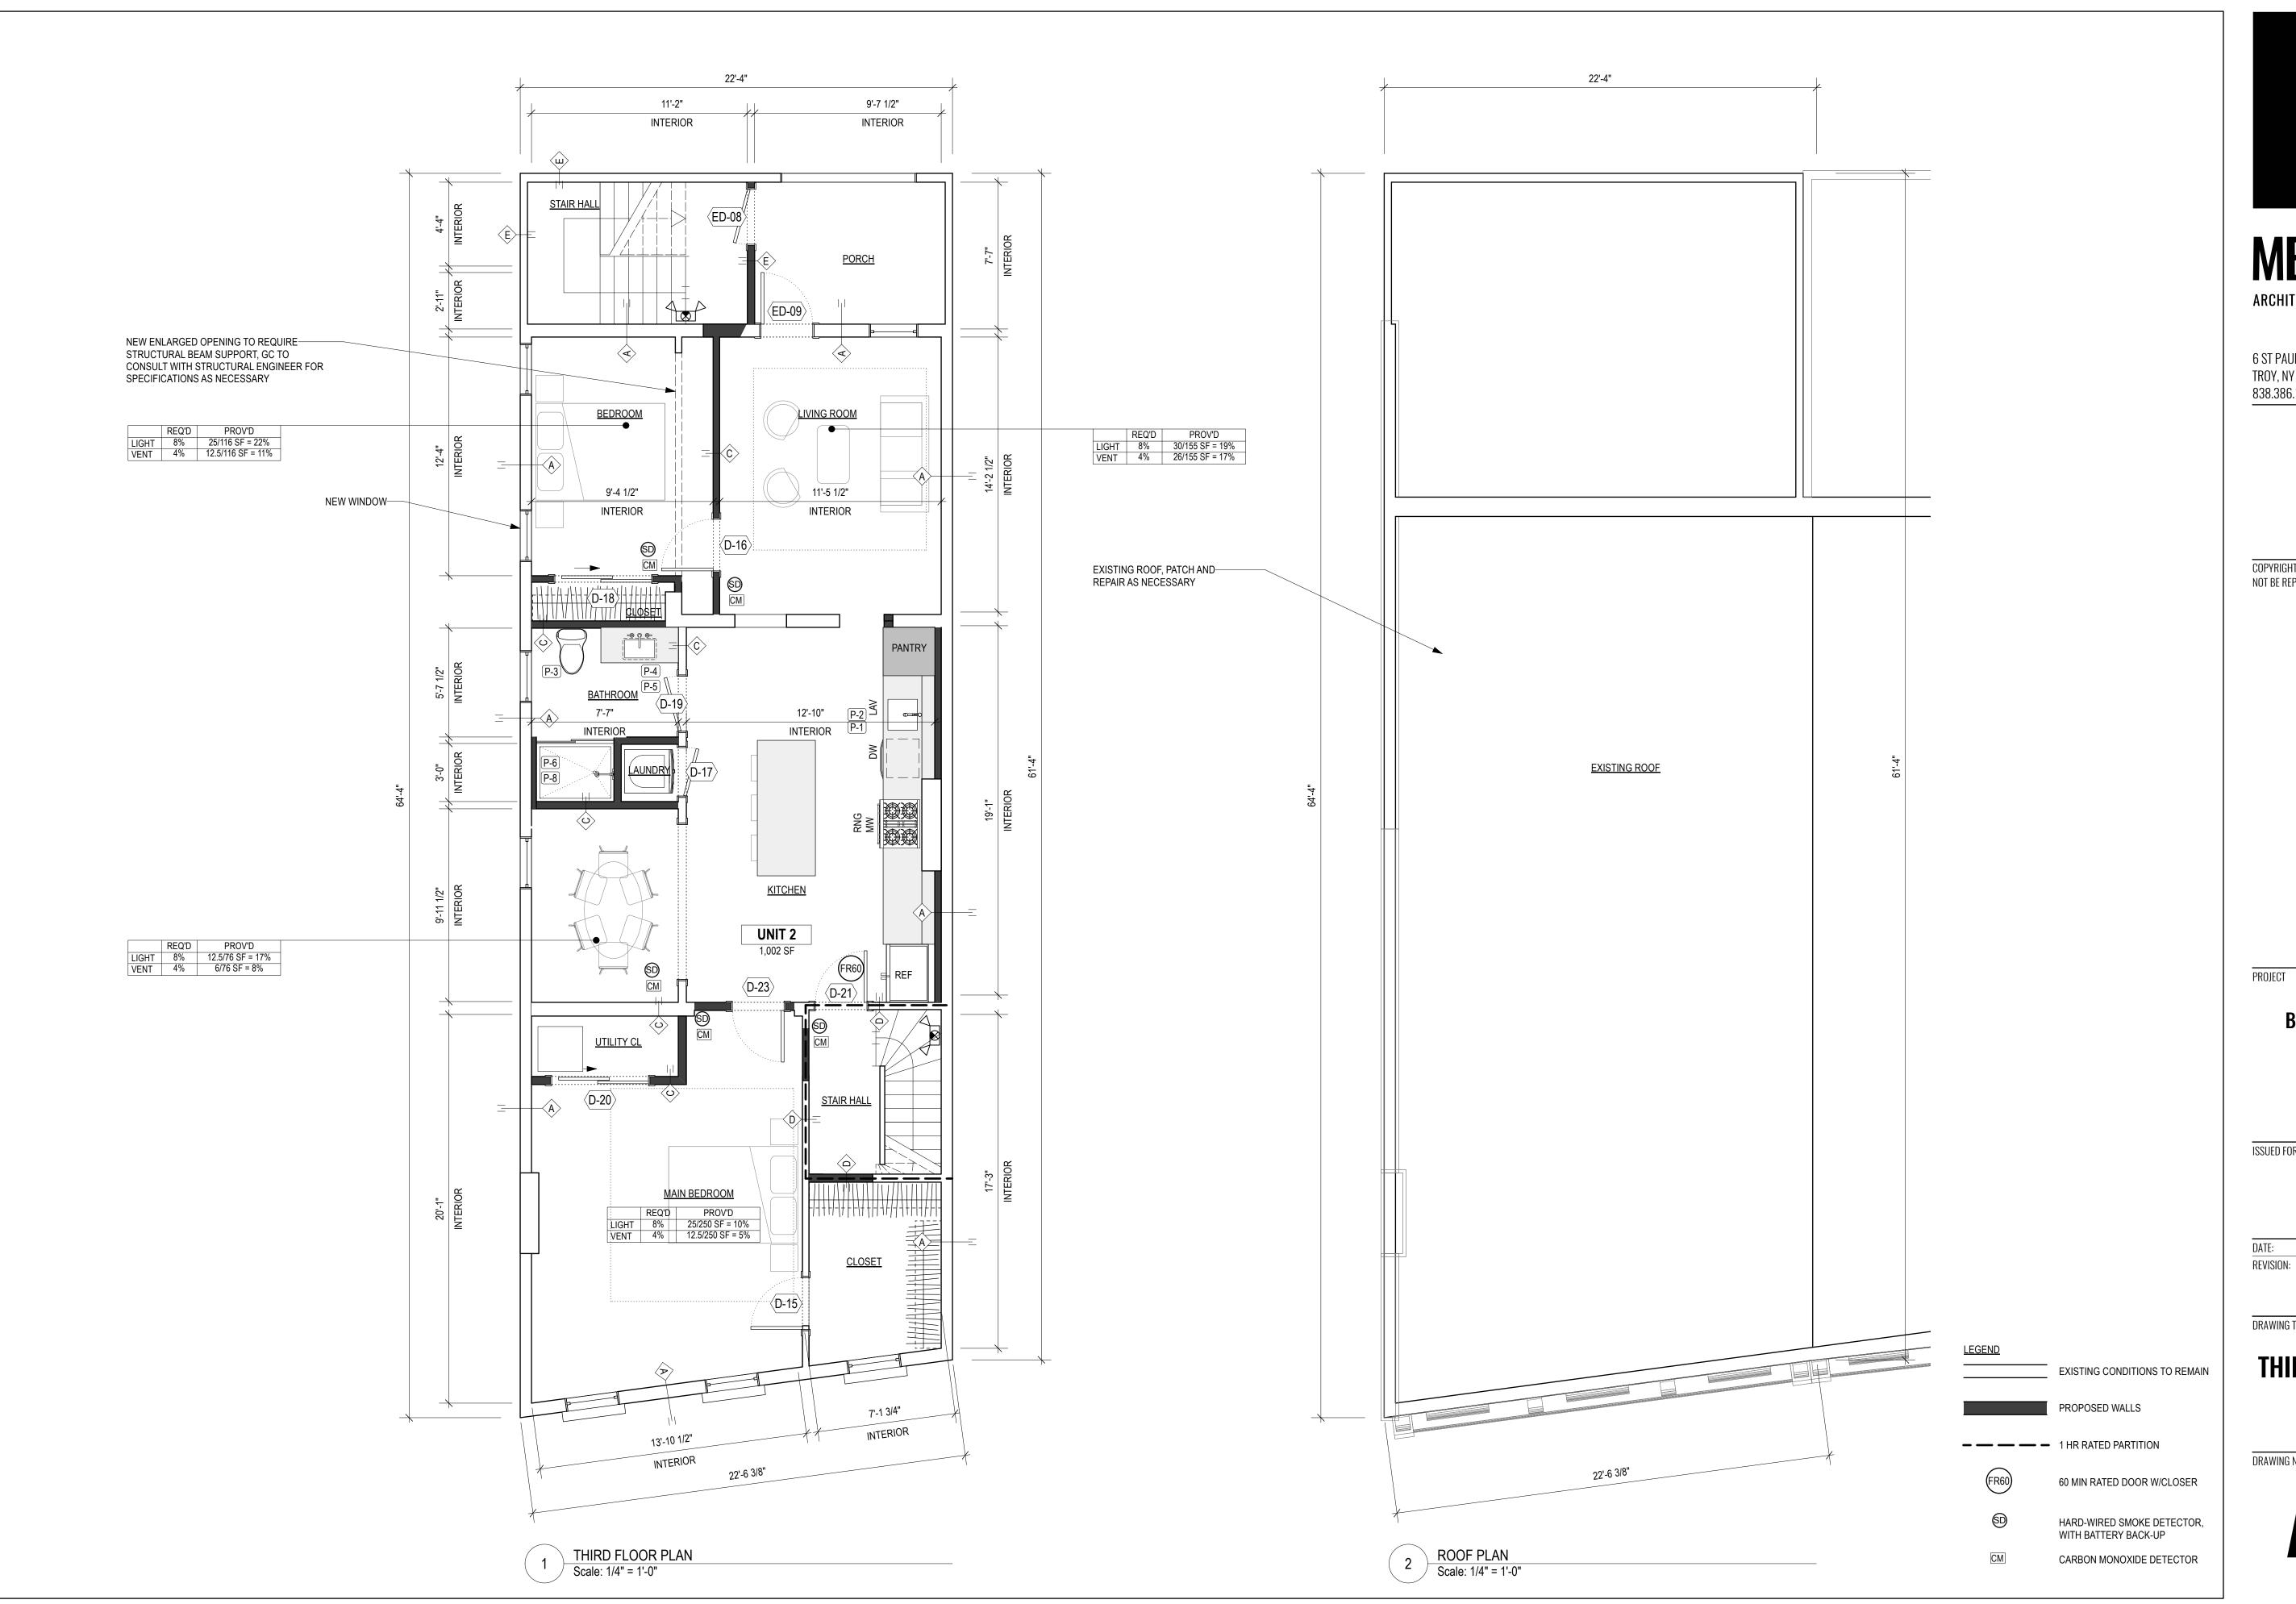
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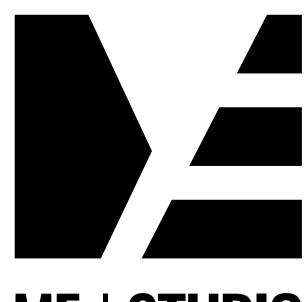
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FIRST & SECOND FLOOR PLAN

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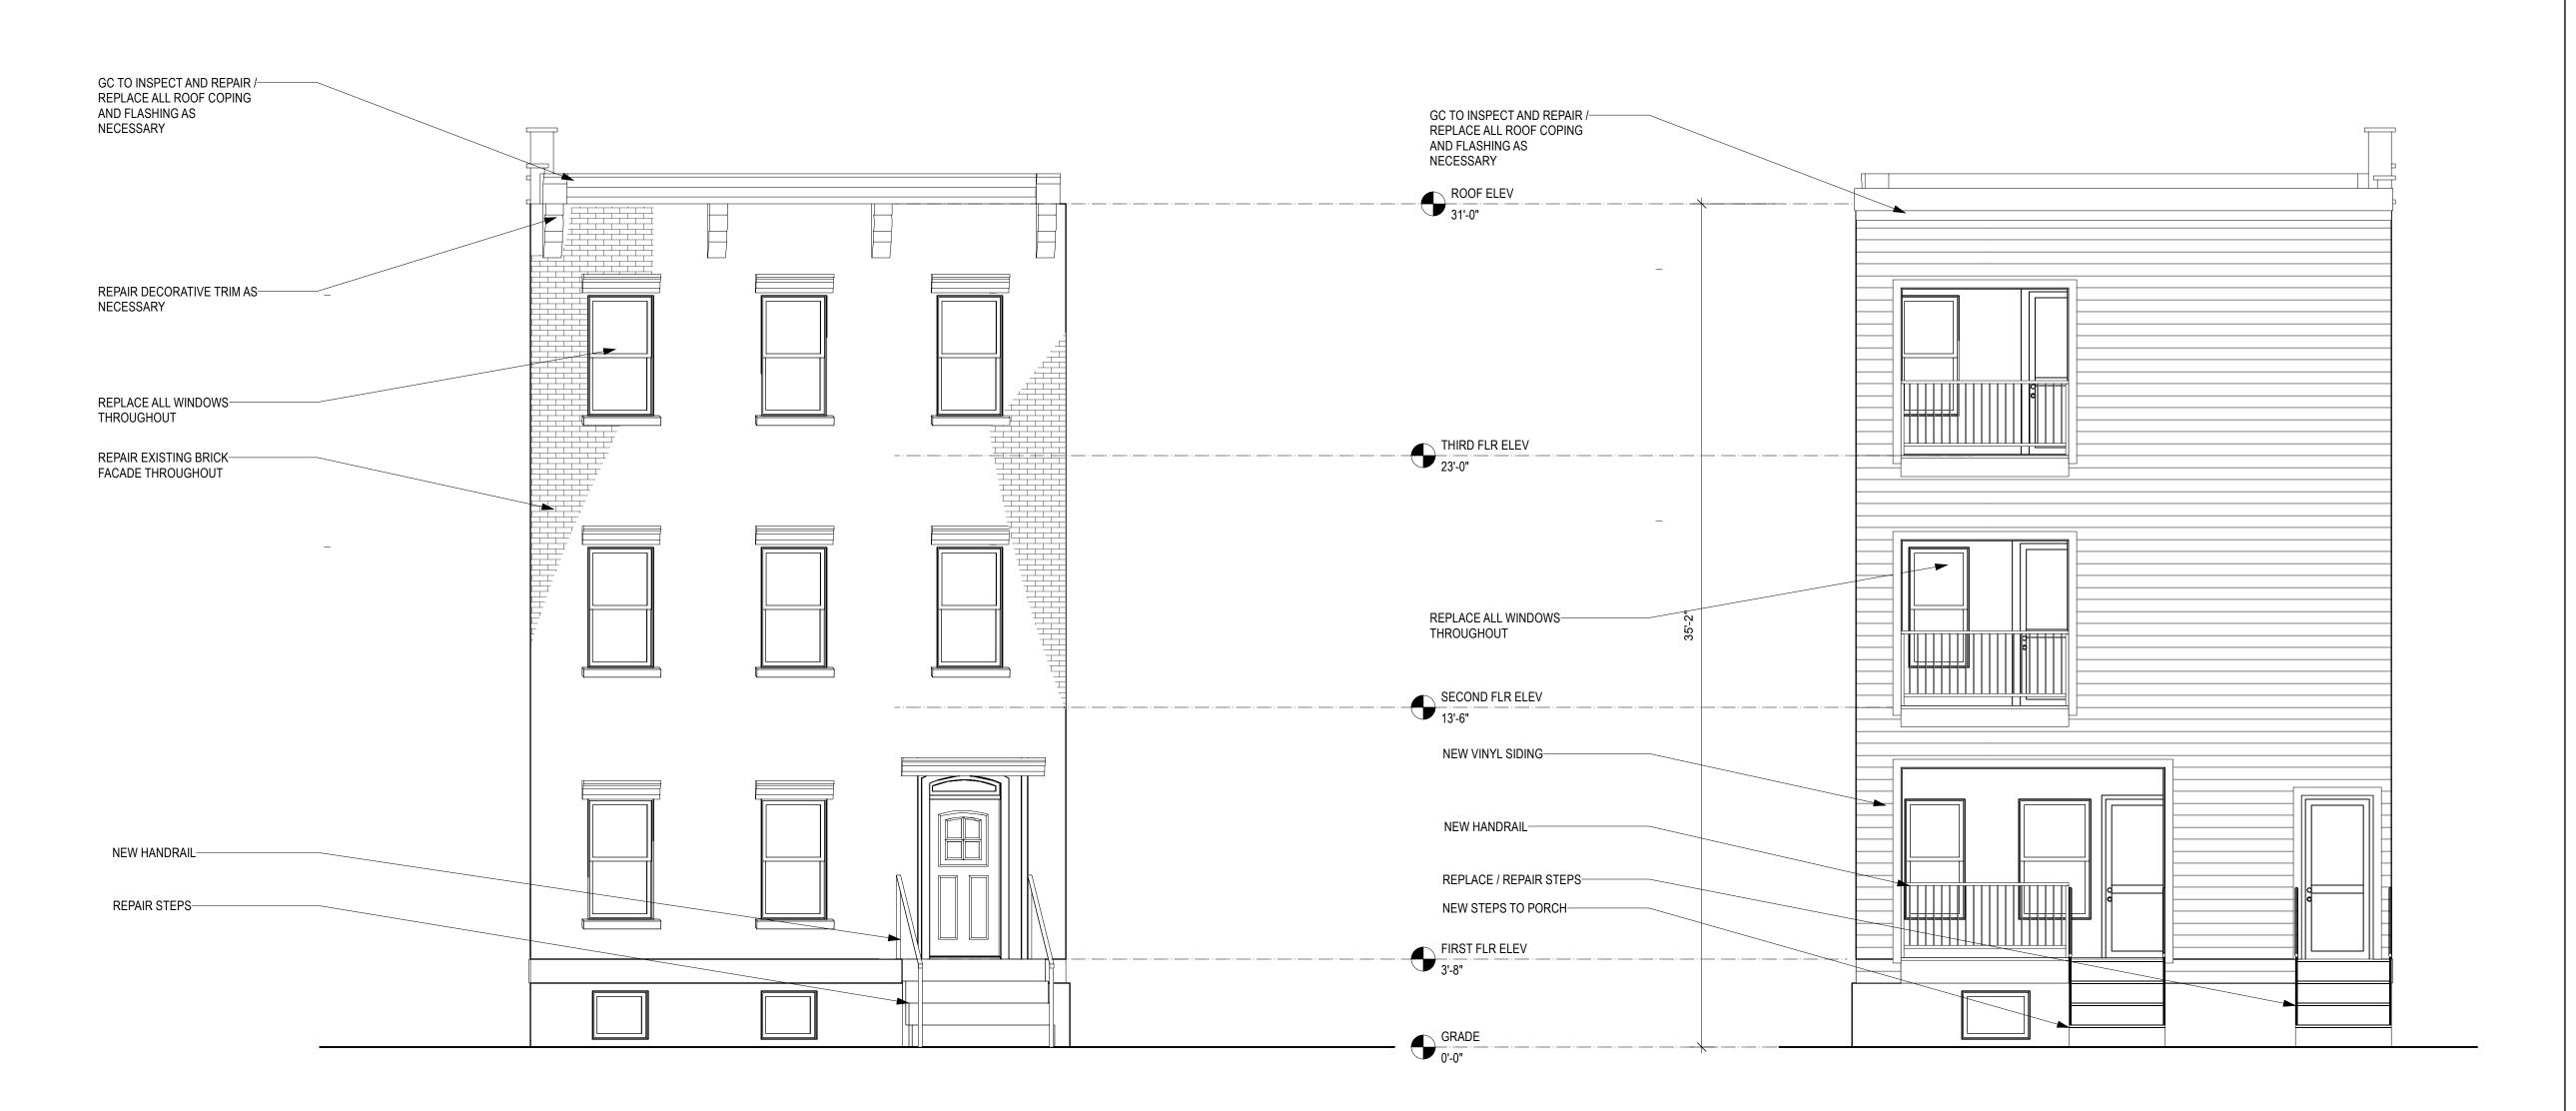
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04/30/25

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THIRD FLOOR & ROOF **PLAN**

DRAWING NUMBER



2 REAR ELEVATION
Scale: 1/4" = 1'-0"

FRONT ELEVATION
Scale: 1/4" = 1'-0"

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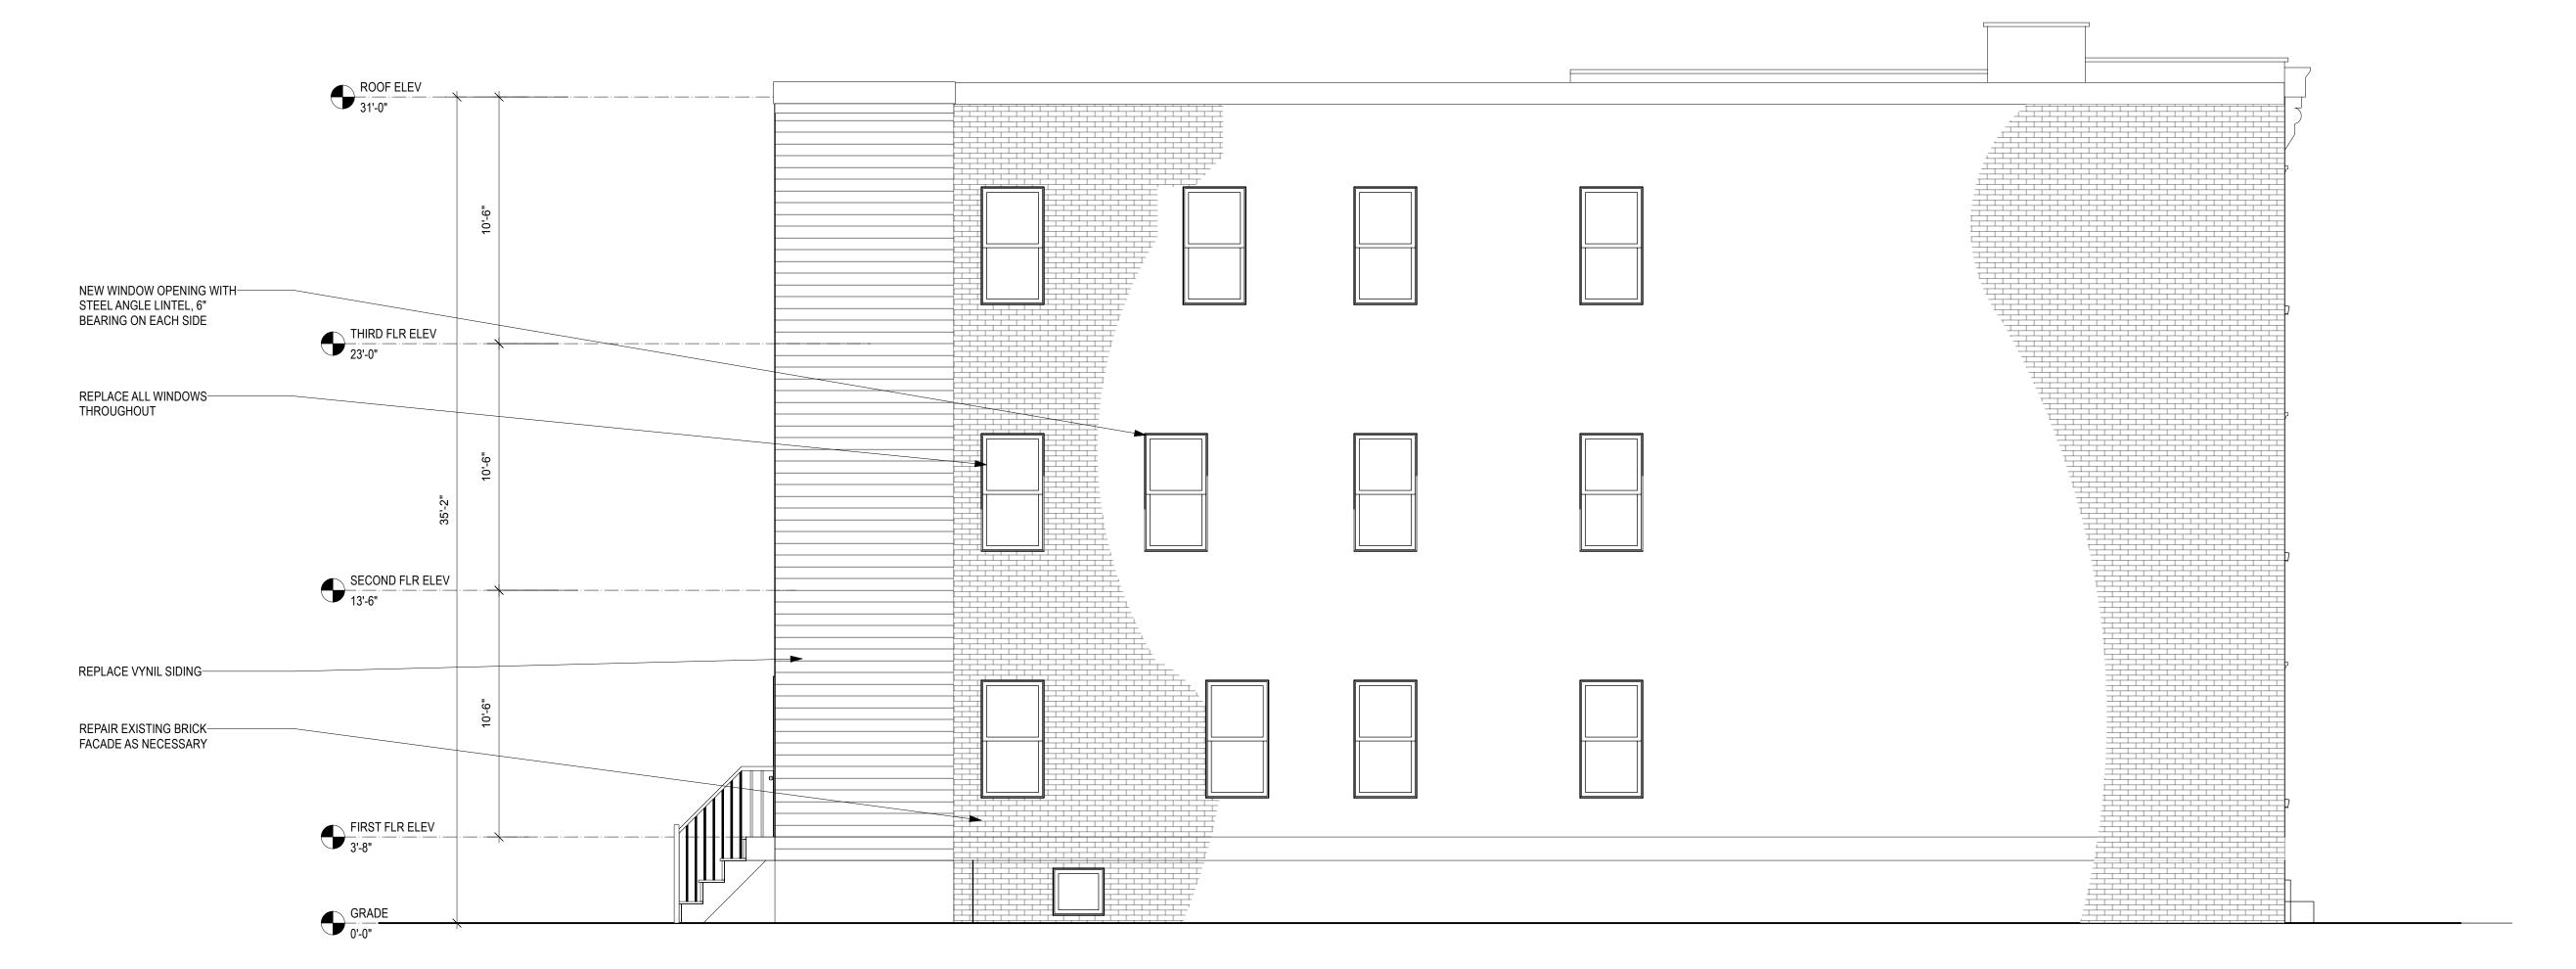
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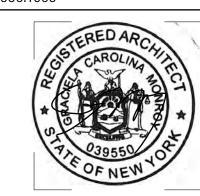






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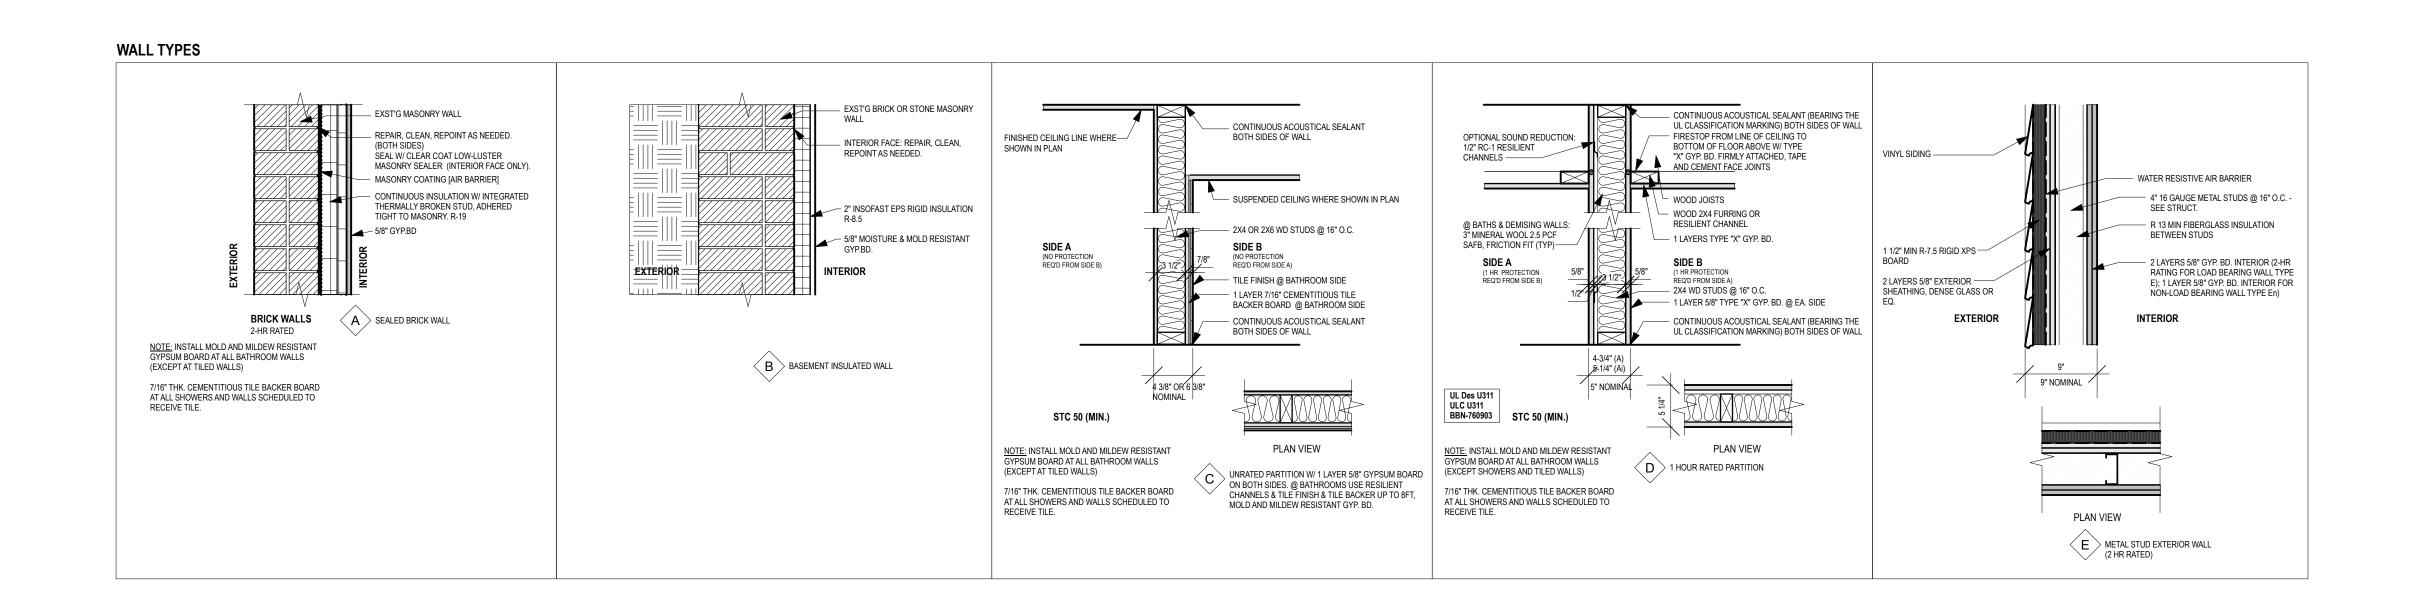
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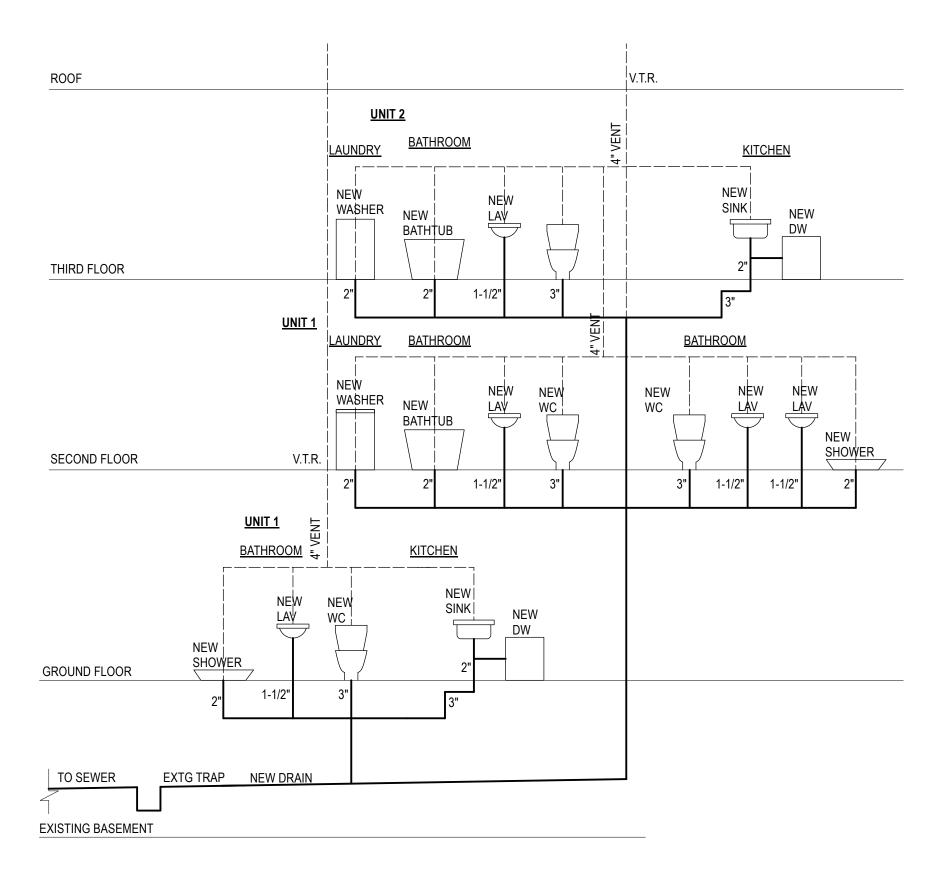
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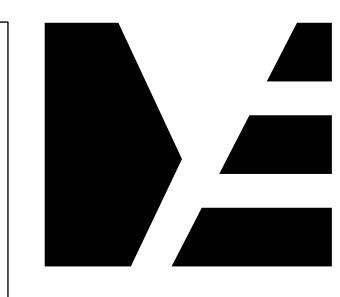
ELEVATIONS

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2 PLUMBING RISER DIAGRAM



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BUILDING ALTERATION

836 RIVER STREET Troy, Ny 12180

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PERMIT

DATE: 04/30/25 REVISION:

DRAWING TITLE

DETAILS

DRAWING NUMBER

Door Scl	nedule															
	Nominal S	Size			Door	Style					Door	Frame	Openir	nas		
				L										-9-		
Mark	Width Height	Thickness		Configuration	Top Shape	Slab Style	Side Lights	L Sidelt Wid	R Sidelt Wid	Glaz. Style	Jamb Thick	Jamb Depth	RO Width	RO Height	HW Set	Comments
D-01			/4" Swing Simple	N/A	Square	Panel		N/A	N/A	None	3/4"	4"	3'0"	6'10"	DHW-#	
D-02 D-03			/4" Swing Simple /4" Swing Simple	N/A N/A	Square Square	Panel Panel		N/A N/A		None None	3/4"	4" ' 1'0"	3'0" 3'1 1/2"	6'10" 6'10 3/4"	DHW-#	
D-03 D-04			/4" Swing Simple /4" Barn Bypass	N/A N/A	Square Square	Panel		N/A N/A		None None	3/4" 3/4"		3'1 1/2" 4'11 1/2"	6'10 3/4" 6'10 3/4"		
D-04 D-05			/4" Swing Simple	N/A N/A	Square	Panel		N/A N/A	IN/ <i>F</i> NI/ <i>L</i>	None	3/4"	4 1/2"	2'9 1/2"	6'10 3/4"	DHW-#	
D-06			/4" Swing Simple	N/A	Square	Panel		N/A N/A		None	3/4"	8"	2'11 1/2"	6'10 3/4"	DHW-#	
D-07	2'10" 6'		/4" Swing Simple	N/A	Square	Panel		N/A		None	3/4"	4 1/2"	2'11 1/2"	6'10 3/4"	DHW-#	
D-08			/4" Swing Simple	N/A	Square	Panel		N/A		None	3/4"		2'9 1/2"	6'10 3/4"	DHW-#	
D-09			/4" Swing Simple	N/A	Square	Panel		N/A		None	3/4"	4 1/2"	2'9 1/2"	6'10 3/4"		
D-10		10" 1 3	/4" Swing Simple	N/A	Square	Panel		N/A		None	3/4"	4 1/2"	2'9 1/2"	6'10 3/4"	DHW-#	
D-11	2'8" 6'		/4" Swing Simple	N/A	Square	Panel		N/A		None	3/4"	4 1/2"	2'9 1/2"	6'10 3/4"	DHW-#	
D-12		<u>10"</u> 1 3	/4" Swing Simple	N/A	Square	Panel		N/A	N/A	None	3/4" 3/4"	4 1/2"	2'9 1/2"	6'10 3/4"	DHW-#	
D-13			/4" Slider	XO	Square	Panel		N/A		None	3/4"	4 1/2"	6'1 1/2"	6'10 3/4"	DHW-#	
D-14			/4" Bi-fold Simple	N/A	Square	Panel		N/A		None	3/4"		3'1 1/2"	6'10 3/4"		
D-15		<u>10"</u> 1 3	/4" Swing Simple	N/A	Square	Panel		N/A		None	3/4"	4"	2'9 1/2"	6'10 3/4"	DHW-#	
D-16			/4" Swing Simple	N/A	Square	Panel		N/A		None	3/4"	4"	2'9 1/2"	6'10 3/4"		
D-17			/4" Swing Simple	N/A	Square	Panel		N/A		None	3/4"		2'7 1/2"	6'10 3/4"		
D-18			/4" Slider	XO	Square	Panel		N/A	N/A	None	3/4"	4"	5'1 1/2"	6'10 3/4"	DHW-#	
D-19			/4" Swing Simple	N/A	Square	Panel		N/A		None	3/4"	5"	2'11 1/2"	6'10 3/4"	DHW-#	
D-20		10" 1 3	/4" Slider	XO	Square	Panel	-	N/A		None	3/4"		5'1 1/2"	6'10 3/4"		
D-21		10" 1 3 10" 1 3	/4" Swing Simple /4" Swing Simple	N/A N/A	Square	Panel		N/A		None None	3/4"		2'9 1/2"	6'10 3/4" 6'10 3/4"	DHW-#	
D-22					Square	Panel	+	N/A			3/4" 3/4"	6"	2'9 1/2"			
D-23 ED-01		10" 1 3 6'8" 1 3	/4" Swing Simple /4" Swing Simple	N/A N/A	Square	Panel Custom		N/A N/A	N/ <i>F</i>	None None	3/4"	5"	2'9 1/2" 3'1 1/2"	6'10 3/4" 7'4 1/2"	DUW #	PROVIDE WEATHER STRIP AND THRESHOLD (SAFETY GLAZING REQUIRED)
ED-01		6'8" 1 3	/4" Swing Simple	N/A N/A	Segment Square	Panel	1	N/A N/A		None	3/4"		2'9 1/2"	6'8 3/4"	DHW#	IFROVIDE WEATHER STRIF AND THRESHOLD (SAFETT GLAZING REQUIRED)
ED-02			/4" Swing Simple	N/A	Square	Panel	1	N/A N/A		None	3/4"		2'9 1/2"	6'8 3/4"	DHW-#	
ED-05	2'8" 6'	10" 13	/4" Swing Simple	N/A	Square	Panel	†	N/A N/A		None	3/4"	4 1/2"	2'9 1/2"	6'10 3/4"	DHW-#	
ED-06			/4" Swing Simple	N/A	Square	Panel		N/A		None	3/4"		2'11 1/2"	6'10 3/4"	DHW-#	
ED-07			/4" Swing Simple	N/A	Square	Panel		N/A		None	3/4"		2'11 1/2"	6'10 3/4"		
ED-07	2'10" 6'		/4" Swing Simple	N/A	Square	Panel		N/A		None	3/4"		2'11 1/2"	6'10 3/4"	DHW-#	
ED-09			/4" Swing Simple	N/A	Square	Panel		N/A		None	3/4"		2'9 1/2"	6'10 3/4"		


OCATION		TYPE	MANUFACTURER	MODEL NAME/NUMBER	FINISH	NOTES
	5.4	IKI L. O. I.	TDD	TDD		
Kitchen	P-1	Kitchen Sink	TBD	TBD		
	P-2	Kitchen Faucet	TBD	TBD		
Bathroom	P-3	Toilet	TBD	TBD		
	P-4	Bathroom Lavatory	TBD	TBD		
	P-5	Bathroom Faucet	TBD	TBD		
	P-6	Showerhead, Tub Spout, & Controls	TBD	TBD		
	P-7	Shower Pan & Drain	TBD	TBD		
	P-8	Bathtub	TBD	TBD		
	P-9	Bathtub spout	TBD	TBD		
	P-10	Exterior Spigot	TBD	TBD		

LOCATION		TYPE	MANUFACTURER	MODEL NAME/NUMBER	NOTES	
Kitchen	EQ-1	Electric Range	TBD	TBD		
	EQ-2	DW	TBD	TBD		
	EQ-3	Refrigerator / Freezer	TBD	TBD		
	EQ-4	Microwave	TBD	TBD		
Laundry Closet	EQ-5	Stacked Washer & Dryer	TBD	TBD		
Mechanical Room	WH-1	Water Heater	TBD	TBD		



ARCHITECTURE . DESIGN . DEVELOPMENT

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PROJEC

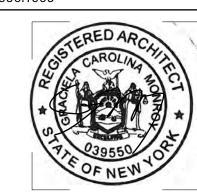BUILDING ALTERATION

836 RIVER STREET TROY, NY 12180

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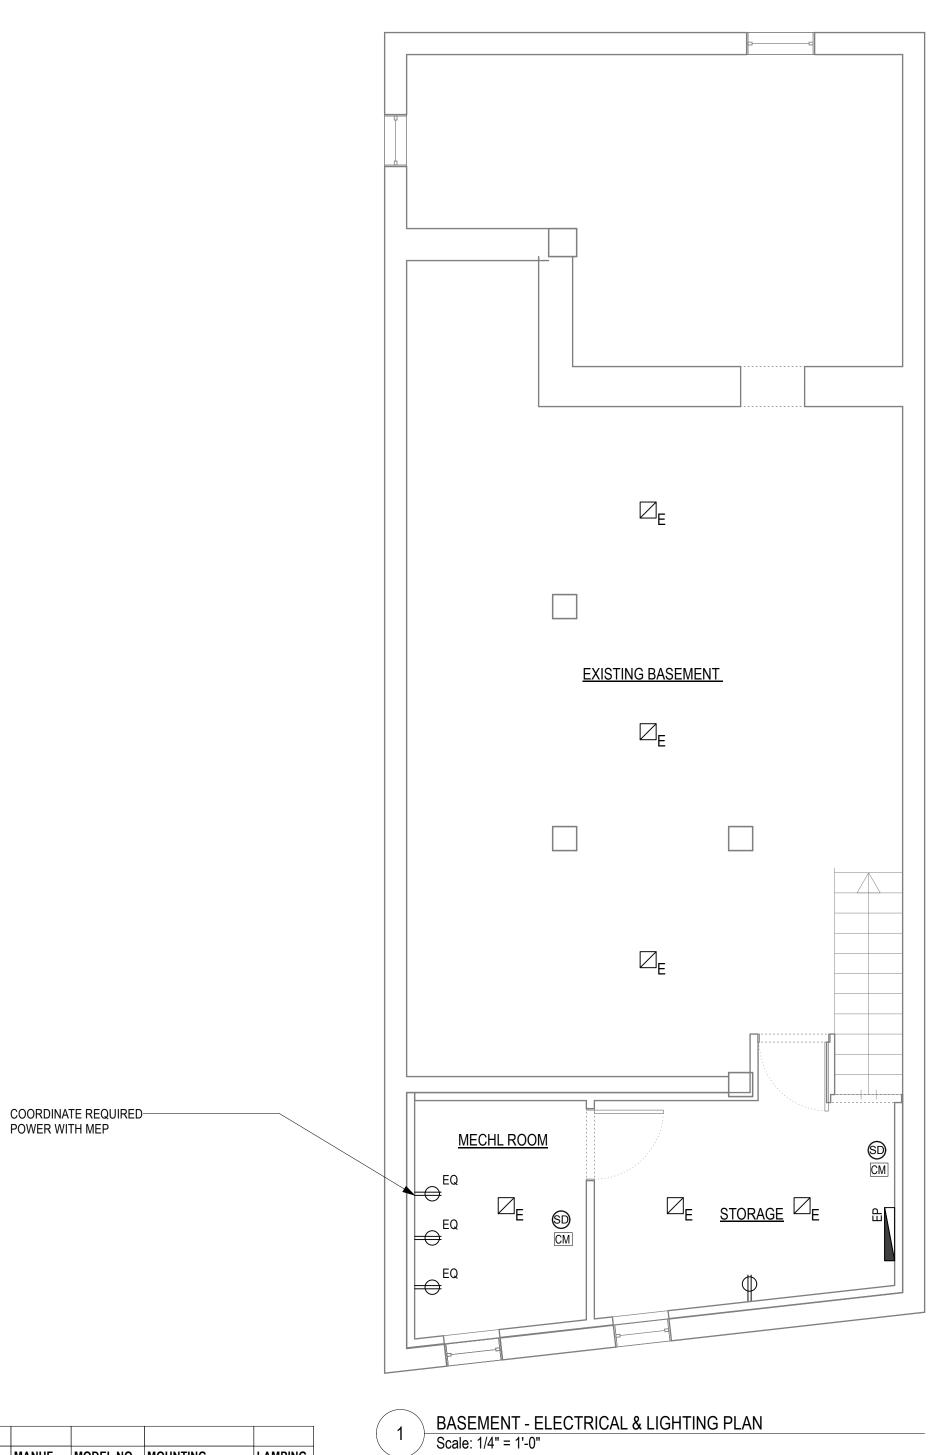
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DATE: 04/30/25
REVISION:


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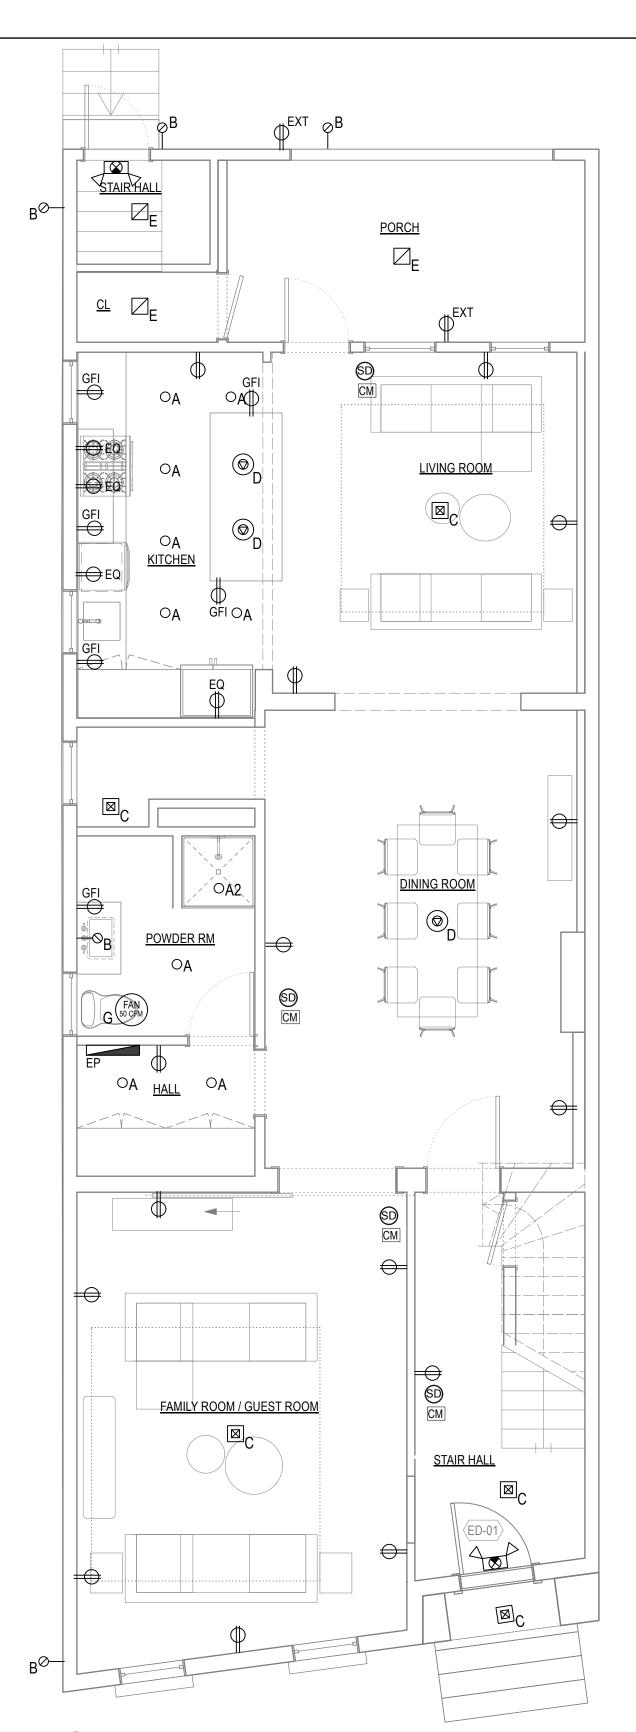
SCHEDULES

DRAWING NUMBER



LIGHT FI	XTURE S	CHEDULE				
FIXTURE	SYMBOL	DESCRIPTION	MANUF.	MODEL NO.	MOUNTING	LAMPING
A	ОА	RECESSED LED DOWNLIGHT. A-2 DENOTES WET RATED.	TBD	TBD	RECESSED	2.5 W LED
В	—⊘ _B	DECORATIVE WALL SCONCE	TBD	TBD	WALL MOUNTED	2.5 W LED
С	⊠ _C	CEILING MOUNTED DECORATIVE PENDANT	TBD	TBD	CEILING MOUNTED	20 W
D	(D)	CEILING MOUNTED DECORATIVE PENDANT	TBD	TBD	CEILING MOUNTED	20 W
E	\square_{E}	CEILING MOUNTED LED UTILITY FIXTURE	TBD	TBD	CEILING MOUNTED	5 W LED
F	F	UNDERCABINET LED STRIP	TBD	TBD	CEILING MOUNTED	2 W LED
Н	J H	CEILING MOUNTED TRACK LIGHT	TBD	TBD	CEILING MOUNTED	5 W LED



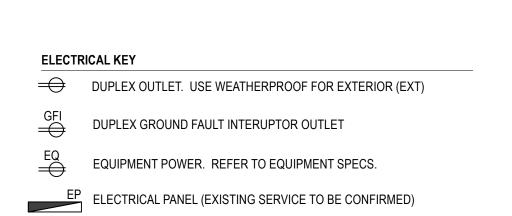

FIRST FLOOR - LIGHTING & ELECTRICAL PLAN
Scale: 1/4" = 1'-0"

- ELECTRICAL NOTES

 1. Electrical service to the Building shall not be overloaded by proposed renovations.

 2. AFCI protection shall be provided for all new general purpose receptacle branch circuits. All new general purpose receptacles
- shall be tamper resistant type as required.

 3. All affected electrical components, wiring, fixtures, etc. within the building shall be examined by a licensed electrician prior to installation of finished surfaces to verify that all complies with applicable Codes and standards.

 4. A licensed electrician shall perform all electrical repairs, modifications, etc.

 5. GC to coordinate walk-thru with Owner to confirm all device locations prior to running wire to exact locations.



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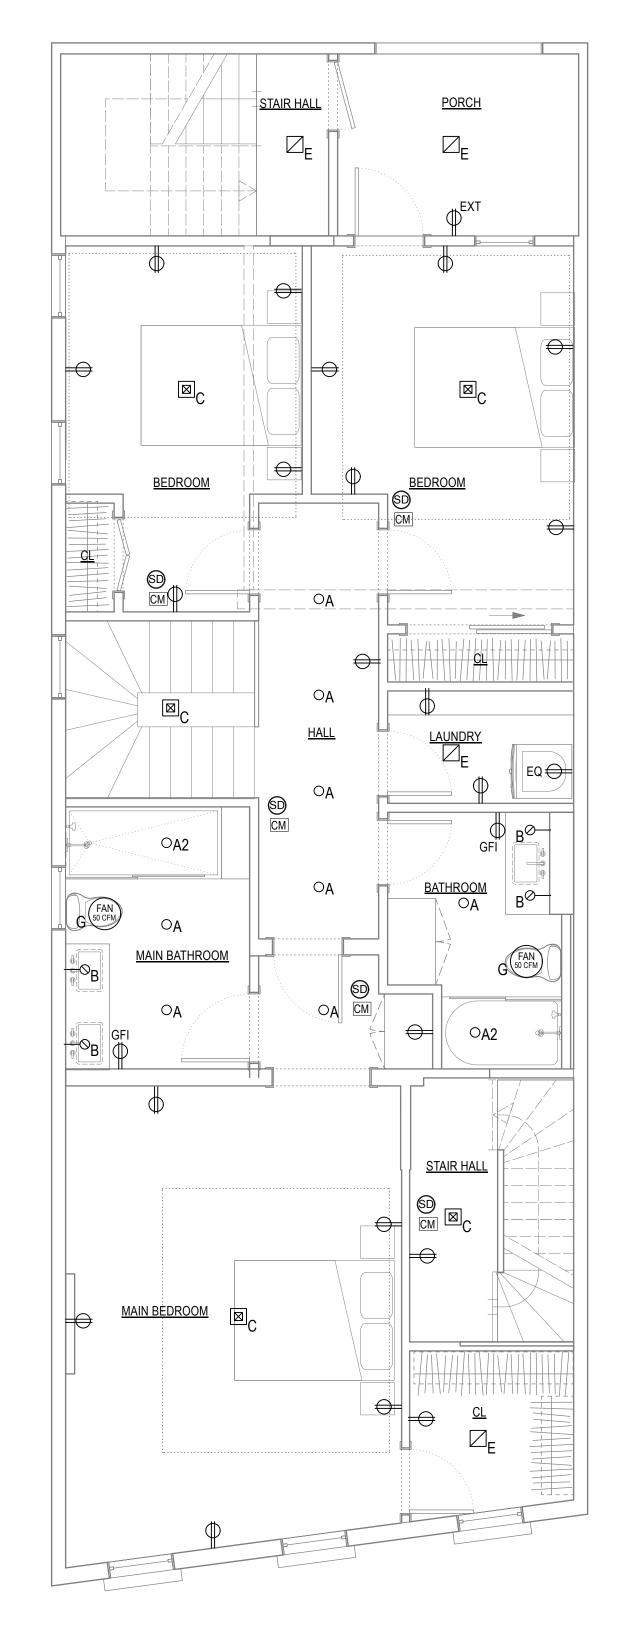
DATE: 04/30/25 **REVISION:**

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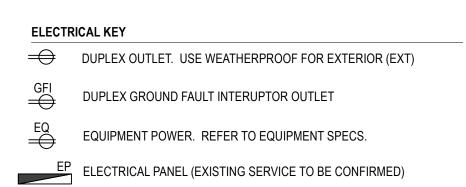
ELECTRICAL & LIGHTING PLANS

DRAWING NUMBER


E-100



LIGHT FIX	XTURE S	CHEDULE				
FIXTURE	SYMBOL	DESCRIPTION	MANUF.	MODEL NO.	MOUNTING	LAMPING
A	ΟA	RECESSED LED DOWNLIGHT. A-2 DENOTES WET RATED.	TBD	TBD	RECESSED	2.5 W LED
В	—⊘ _B	DECORATIVE WALL SCONCE	TBD	TBD	WALL MOUNTED	2.5 W LED
С	\boxtimes_{C}	CEILING MOUNTED DECORATIVE PENDANT	TBD	TBD	CEILING MOUNTED	20 W
D	O D	CEILING MOUNTED DECORATIVE PENDANT	TBD	TBD	CEILING MOUNTED	20 W
E	\square_{E}	CEILING MOUNTED LED UTILITY FIXTURE	TBD	TBD	CEILING MOUNTED	5 W LED
F	F	UNDERCABINET LED STRIP	TBD	TBD	CEILING MOUNTED	2 W LED
Н	Z H	CEILING MOUNTED TRACK LIGHT	TBD	TBD	CEILING MOUNTED	5 W LED



SECOND FLOOR - ELECTRICAL & LIGHTING PLAN
Scale: 1/4" = 1'-0"

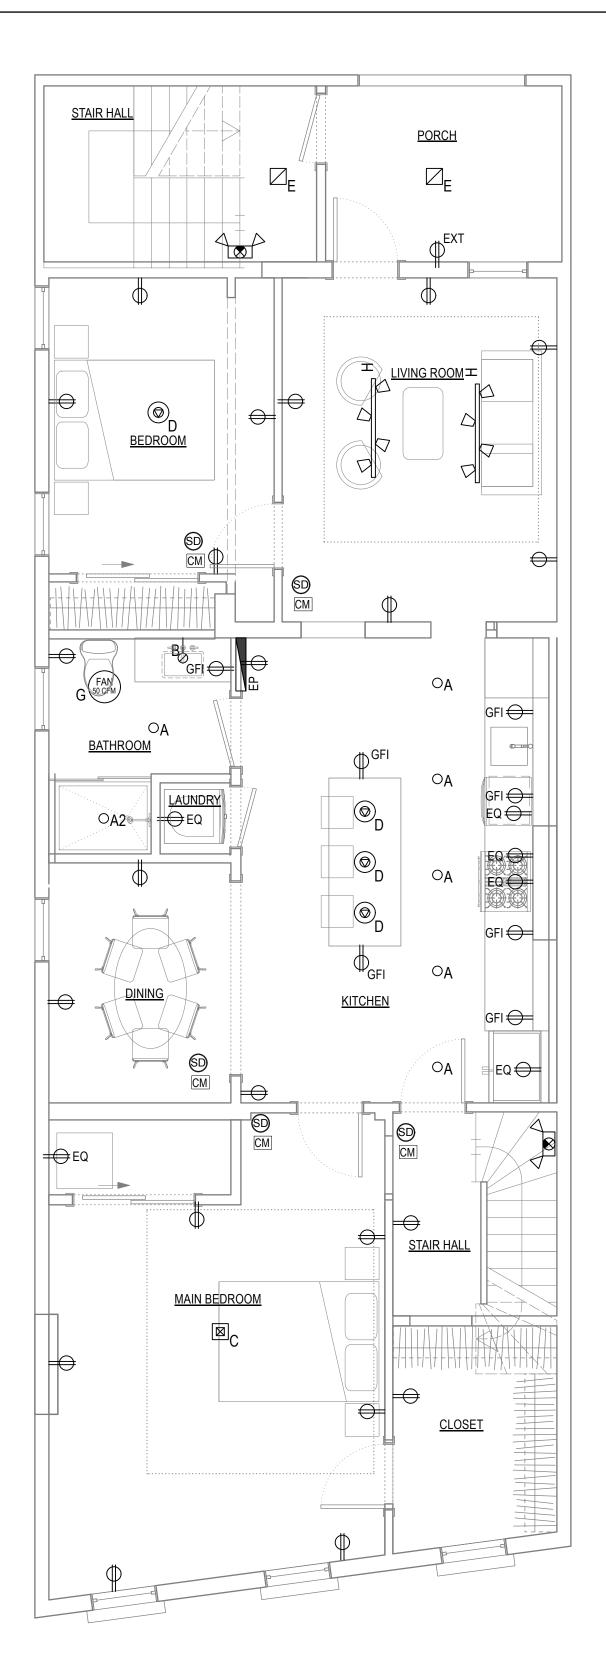

THIRD FLOOR - ELECTRICAL & LIGHTING PLAN Scale: 1/4" = 1'-0"

- ELECTRICAL NOTES

 1. Electrical service to the Building shall not be overloaded by proposed renovations.
- 2. AFCI protection shall be provided for all new general purpose receptacle branch circuits. All new general purpose receptacles
- shall be tamper resistant type as required.

 3. All affected electrical components, wiring, fixtures, etc. within the building shall be examined by a licensed electrician prior to installation of finished surfaces to verify that all complies with applicable Codes and standards.

 4. A licensed electrician shall perform all electrical repairs, modifications, etc.

 5. GC to coordinate walk-thru with Owner to confirm all device locations prior to running wire to exact locations.



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BUILDING ALTERATION

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DRAWING TITLE

ELECTRICAL & LIGHTING PLANS

DRAWING NUMBER

E-101