DECISION BEFORE SUBMISSION OF BID AS TO WHICH METHOD OF MATERIALS WILL BE REQUIRED.

CORRECTED AT THE CONTRACTOR'S EXPENSE.

GENERAL NOTES:

FLOOR LIVE LOADS:

BALCONIES

ROOF SNOW LOAD:

WIND DESIGN DATA:

EXPOSURE

DESCRIPTION OF THE ALTERATIONS WHICH WERE MADE.

NOTES:

CERTIFICATION:

SIGNATURE:

AND INDUSTRIAL CODE RULE 56.

GROUND SNOW LOAD (Pg)

STAIRS

DECKS

SLEEPING ROOMS

CONSERVATION CONSTRUCTION CODE OF NEW YORK STATE).

RESIDENTIAL CODE TECHNICAL SUBCOMMITTEE.

ROOMS OTHER THAN SLEEPING ROOMS

WITH STORAGE, ROOF SLOPE EXCEEDS 3:12

BASIC WIND SPEED (3-SECOND GUST)

WITHOUT STORAGE, ROOF SLOPE 3:12 OR LESS

<u>TABLE R401.4.1 PRESUMPTIVE LOAD—BEARING VALUES OF FOUNDATION MATERIALS</u>

MATCH THE DRAWINGS SHALL BE APPROVED BY THE ARCHITECT PRIOR TO THE EFFECTED WORK BEING STARTED.

RESPONSIBLE FOR THE REVIEW OF ALL DETAILING AND DIMENSIONING. ANY ERRORS IN DIMENSIONING AND/OR DETAILING SHALL BE

1. THE CONTRACTOR SHALL PERFORM ALL WORK IN STRICT ACCORDANCE WITH ALL FEDERAL, STATE AND LOCAL, LOCAL CODES,

THE 2023 BUILDING CODE OF NEW YORK STATE, THE 2023 FIRE CODE OF NEW YORK STATE, AND THE 2023 ENERGY

1 THE WORK SHOWN ON THESE DRAWINGS HAS BEEN DESIGNED IN ACCORDANCE WITH THE 2020 RESIDENTIAL CODE OF NEW

THE NEW YORK MODIFICATIONS DEVELOPED BY THE STATE FIRE PREVENTION AND BUILDING CODE COUNCIL AND ITS

2 THE STRUCTURAL COMPONENTS HAVE BEEN DESIGNED FOR THE FOLLOWING LIVE LOADS:

YORK STATE, WHICH IS THE 2018 INTERNATIONAL RESIDENTIAL CODE (IRC), PART VIII OF THE 2009 RESIDENTIAL CODE AND

40 PSF

30 PSF

40 PSF

60 PSF

40 PSF

20 PSF

10 PSF

50 PSF

115 MPH

IT IS A VIOLATION OF LAW FOR ANY PERSON. UNLESS ACTING UNDER THE DIRECTION OF A LICENSED ARCHITECT OR PROFESSIONAL ENGINEER TO ALTER ANY ITEM ON THIS DOCUMENT IN ANY WAY. ANY LICENSEE WHO ALTERS THIS DOCUMENT IS REQUIRED BY LAW TO AFFIX HIS OR HER SEAL AND THE NOTATION 'ALTERED BY' FOLLOWED BY HIS OR HER SIGNATURE AND A SPECIFIC

ENGINEERING PLANS AND SPECIFICATIONS HAVE BEEN PREPARED BY OR UNDER THE DIRECTION OF THE UNDERSIGNED AND TO THE BEST OF THE UNDERSIGNED'S KNOWLEDGE, INFORMATION AND BELIEF MEET THE REQUIREMENTS OF THE NEW YORK STATE UNIFORM FIRE PREVENTION AND BUILDING CODES, THE STATE ENERGY CONSERVATION CODE. NATIONAL ELECTRICAL CODE.

RULES, REGULATIONS AND ORDINANCES INCLUDING, BUT NOT LIMITED TO, THE 2023 CODE FAMILY OF NEW YORK STATE (INCLUDING

SHOULD CONFLICT OCCUR IN OR BETWEEN SPECIFICATIONS AND DRAWINGS, CONTRACTOR IS DEEMED TO HAVE ESTIMATED ON AND WILL BE RESPONSIBLE FOR THE MORE EXPENSIVE WAY OF DOING WORK UNLESS THE CONTRACTOR SHALL HAVE ASKED FOR AND OBTAINED WRITTEN

THE DRAWINGS INDICATE EXISTING STRUCTURAL AND FRAMING ELEMENTS AND DIMENSIONS TO THE BEST OF THE ARCHITECTS ABILITY. THE CONTRACTOR IS RESPONSIBLE FOR INVESTIGATING ALL EXISTING ELEMENTS TO VERIFY THE ACTUAL CONDITIONS. IF THE ACTUAL CONDITIONS DEVIATE FROM WHAT IS SHOWN ON THE DRAWINGS, THE CONTRACTOR SHALL CONTACT THE ARCHITECT AND MAKE THE ARCHITECT AWARE OF THE ACTUAL CONDITIONS. DEVIATIONS FROM THE DETAILS SHOWN ON THE DRAWINGS CAUSED BY EXISTING CONDITIONS THAT DO NOT

9


7


3


REVISIONS

DATE: 11.06.2024

SHEET No.

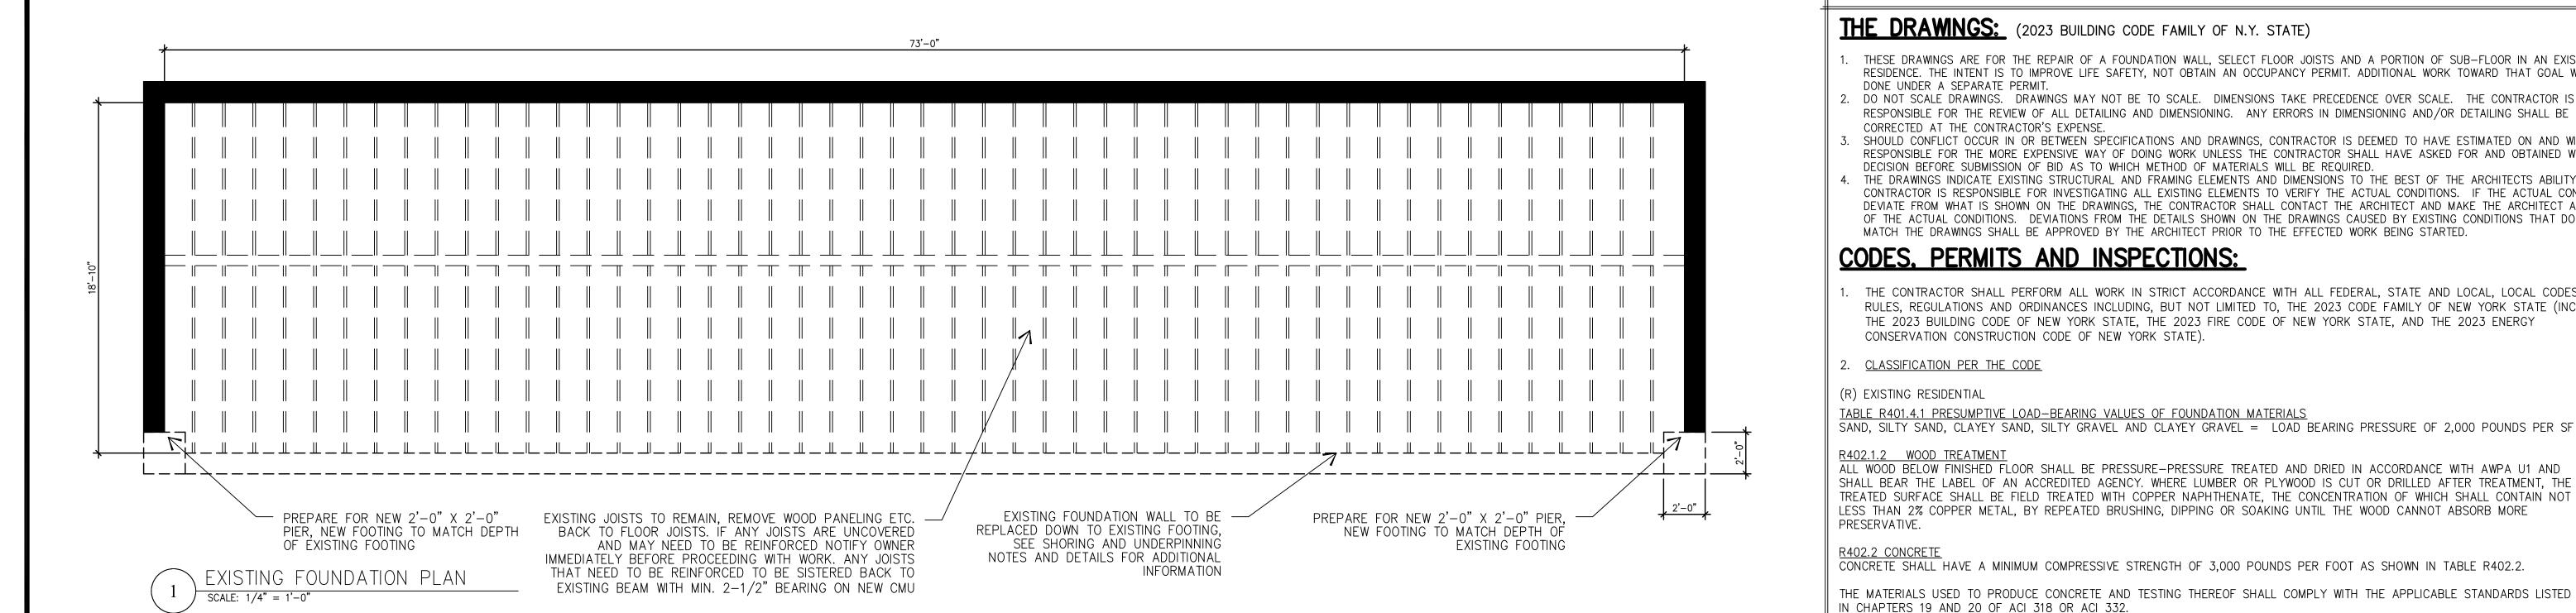

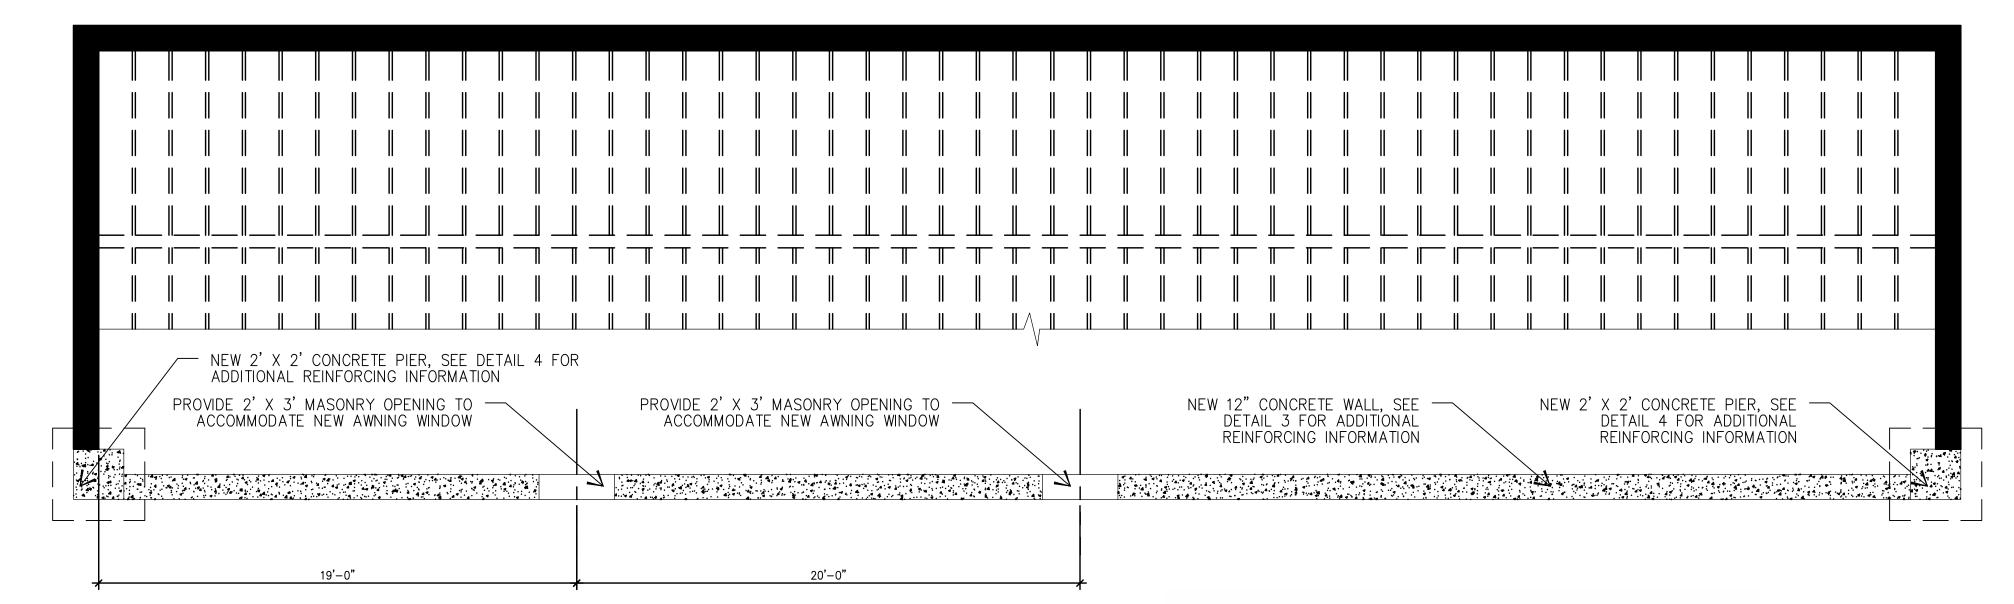

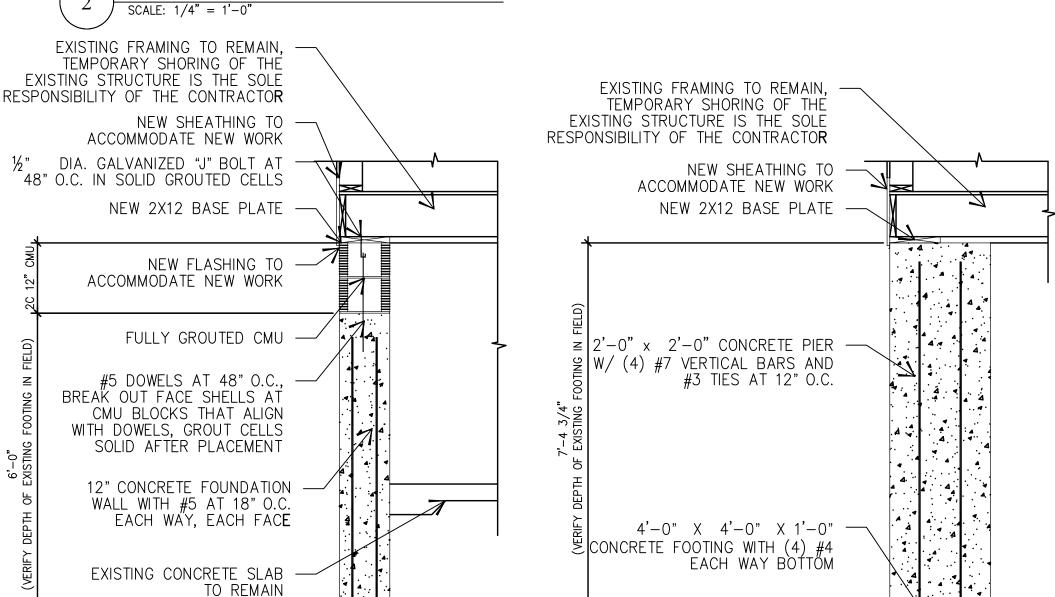

PROPOSED FOUNDATION PLAN

EXISTING FOOTING TO REMAIN \longrightarrow

SCALE: 1/4" = 1'-0"

PROPOSED FOUNDATION WALL

PROPOSED PIER

SCALE: 1/4" = 1'-0"

2 2 — LOWERED GRADE 3'-0" TYP. - NEW CONCRETE UNDERPINNING SEGMENTS, MATCH (E) FOOTING WIDTH


TYPICAL ELEVATION OF UNDERPINNING NO SCALE

UNDERPINNING SEQUENCE

- STARTING WITH SEGMENTS 1 ONLY, DIG PITS 3'-0" WIDE WHILE SIMULTANEOUSLY PLACING REQUIRED SHEETING AND BRACING. PACK VOIDS BETWEEN SHEETING AND SOIL. (LEAVE A MINIMUM OF 6'-0" OF EXISTING SOIL BETWEEN PITS)
- POUR NEW CONCRETE UNDERPINNING FOR SEGMENTS 1. AFTER CONCRETE HAS CURED THREE-DAYS, INSTALL DRYPACK GROUT INTO SPACE BETMEEN TOP OF UNDERPINNING AND BOTTOM OF EXISTING FOOTING TO TRANSFER LOAD. LET DRYPACK CURE ONE-DAY.
- FOR SEGMENTS 2 ONLY, DIG PITS 3'-O" WIDE WITH REQUIRED SHEETING AND BRACING
- FOR SEGMENTS 2, REPEAT CONCRETING AND DRYPACKING AS DESCRIBED IN NOTE B.
- FOR SEGMENTS 3, DIG OUT SOIL BETWEEN COMPLETED SEGMENTS 1 AND 2. PROVIDE SHEETING
- F. FOR SEGMENT 3, REPEAT CONCRETING AND DRYPACKING AS DESCRIBED IN NOTE B.
- G. ALL SHEETING AND BRACING TO REMAIN SHALL BE TREATED TO PREVENT DECOMPOSITION.

TYP. UNDERPINNING DETAILS 3/4" = 1'-0"

AS AN ALTERNATE DESIGN FOR THE FOUNDATION WALL. 12" CMU CAN BE SUBSTITUTED FOR THE CONCRETE WITH (2)-#5 BARS AT 32" O.C. AND GROUT THE ENTIRE WALL SOLID. USE 9GA LADDER-TYPE **DURO-WALL REINFORCEMENT AT EVERY** OTHER COURSE FOR HORIZONTAL REINFORCEMENT WITH A BOND BEAM WITH (2)-#5 HORIZONTAL BARS ONE COURSE DOWN FROM THE TOP OF THE WALI

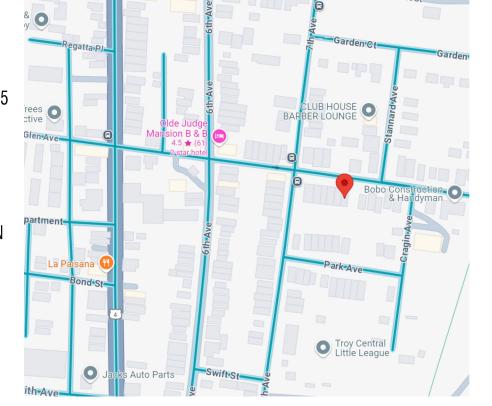

Cristopher & Schrader



VICINITY MAP

PLAT PLAN

SHEET TITLE:

-PLANS--DETAILS-